





WATER FEATURE-

STRUCTUAL DETAILS

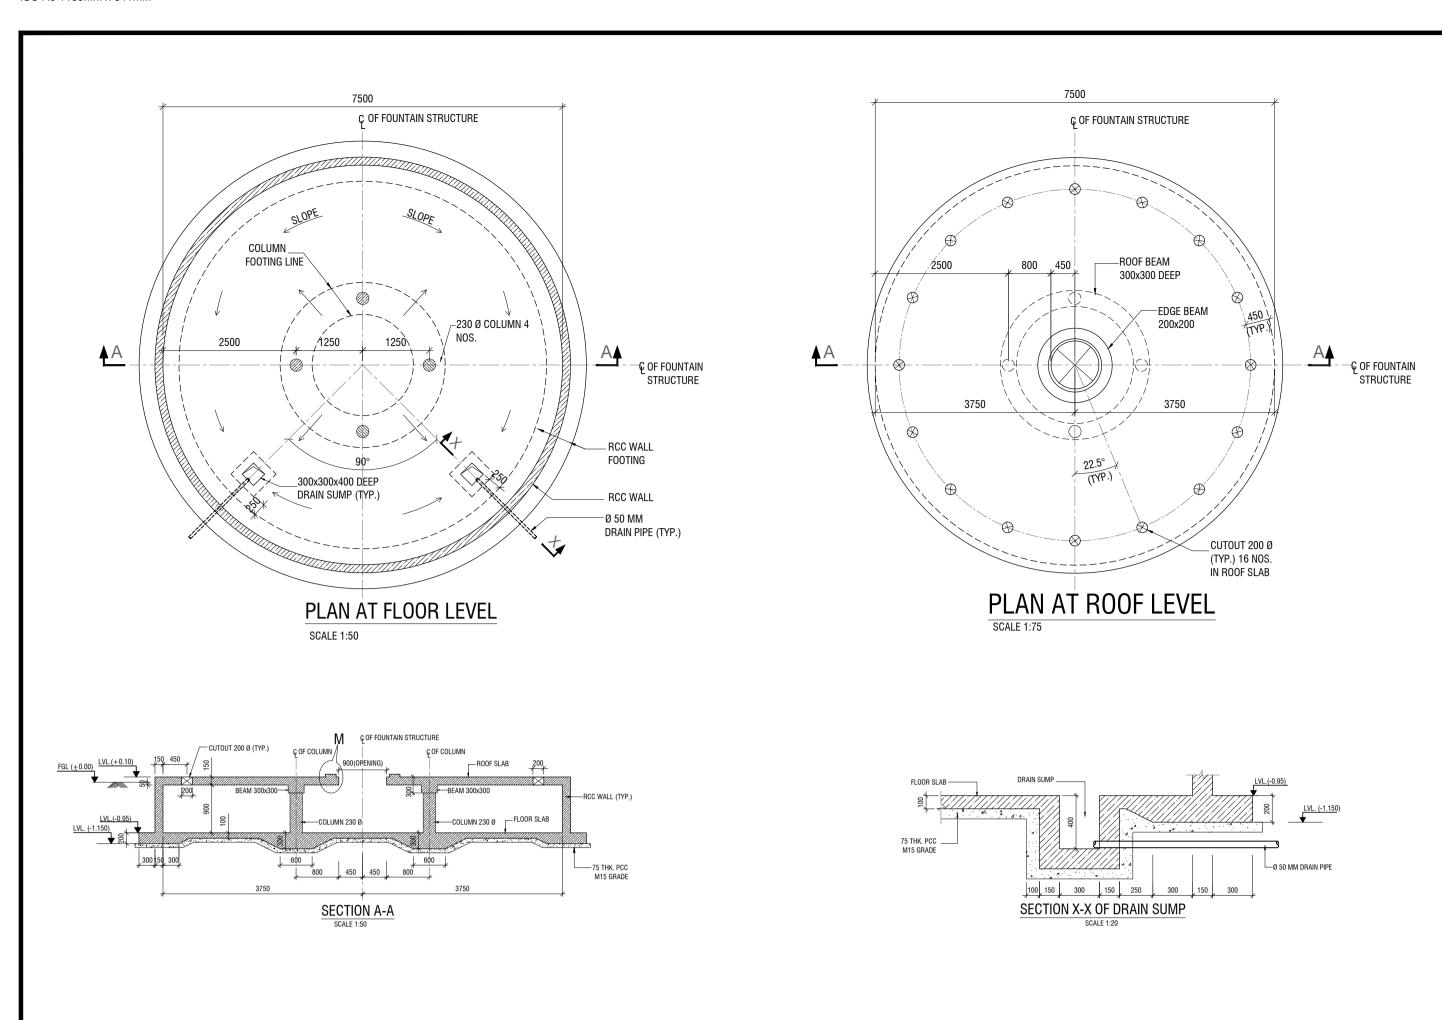

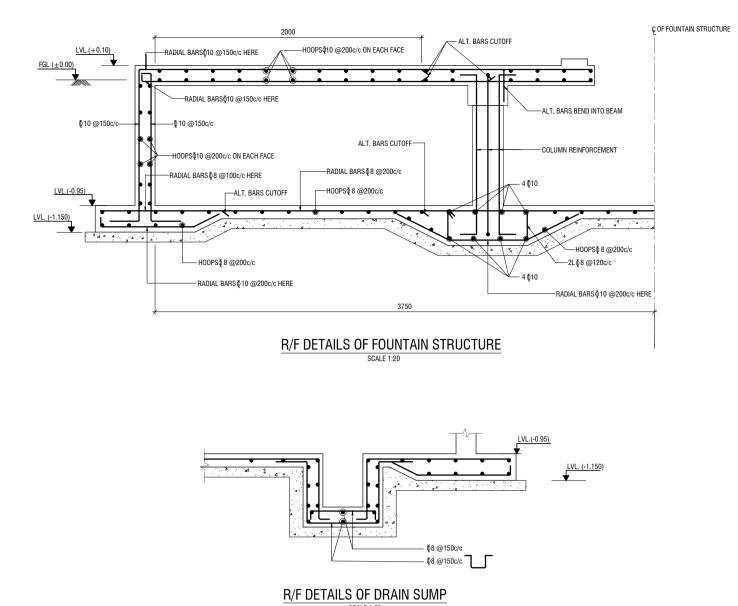

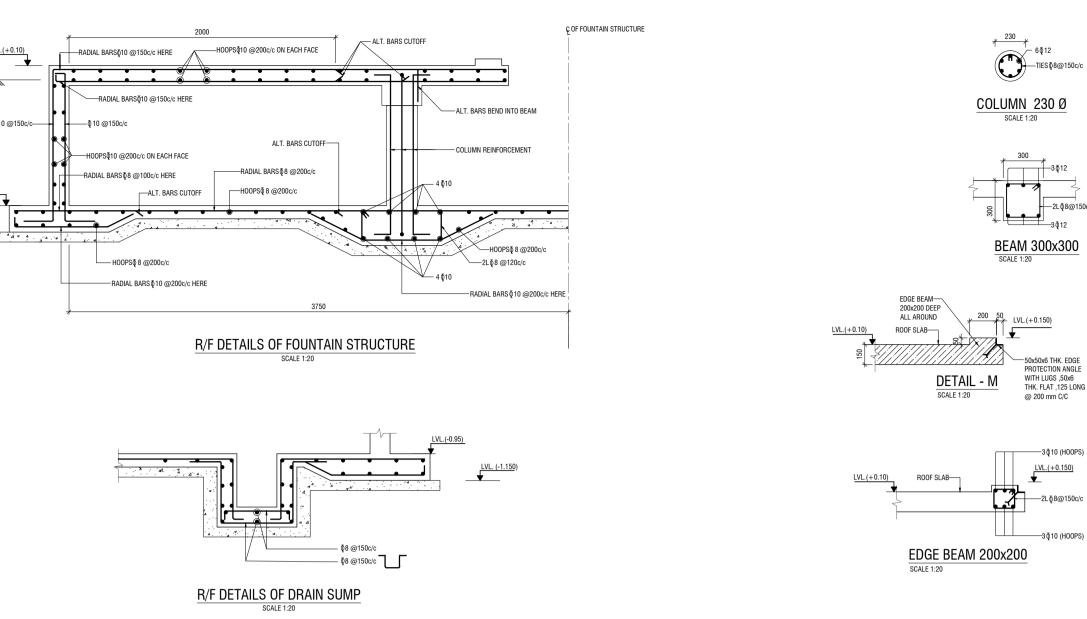

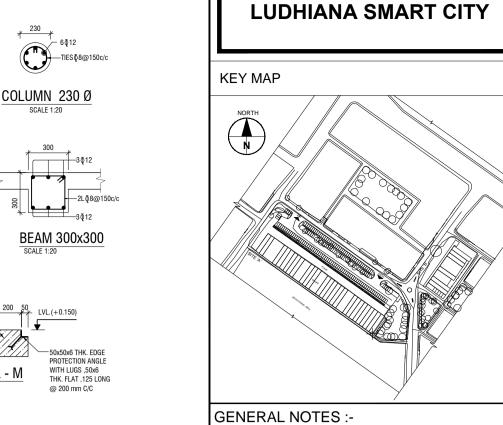

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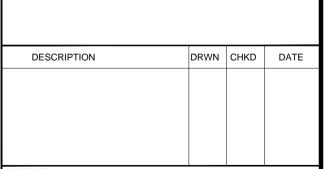
IT IS THE RESPONSIBILITY OF THE BIDDER TO ASCERTAIN EXISTING SITE AREA AND CONDITION ALONG WITH INFORMATION PROVIDED IN DRAWING.

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TOP BAR

THE SATISFACTION OF THE ENGINEER IN CHARGE.				
LEGENDS:-				
FINISH GROUND LEVEL.	FGL.			
TOP OF CONCRETE	TOC			
BOTTOM OF LINTEL	BOL			
UNLESS NOTED OTHERWISE.	UNO.			
BRICK WALL				
RCC MEMBER				
PCC				
STEEL MEMBER				
SAND				
OPENING				
DEPRESSION				
BOTTOM BAR				



LUDHIANA SMART CITY LIMITED


RETROFITTING AND FACADE IMPROVEMENT OF SARABHA NAGAR MARKET


PRELIMINARY DESIGN REPORT


FOR TENDER


RETROFITTING SCHEME-PROPOSED MATERIAL PALETTE-STRUCTURAL DETAILS


A0 DELD-LSCL-100 -TP- RSN- 3005 B

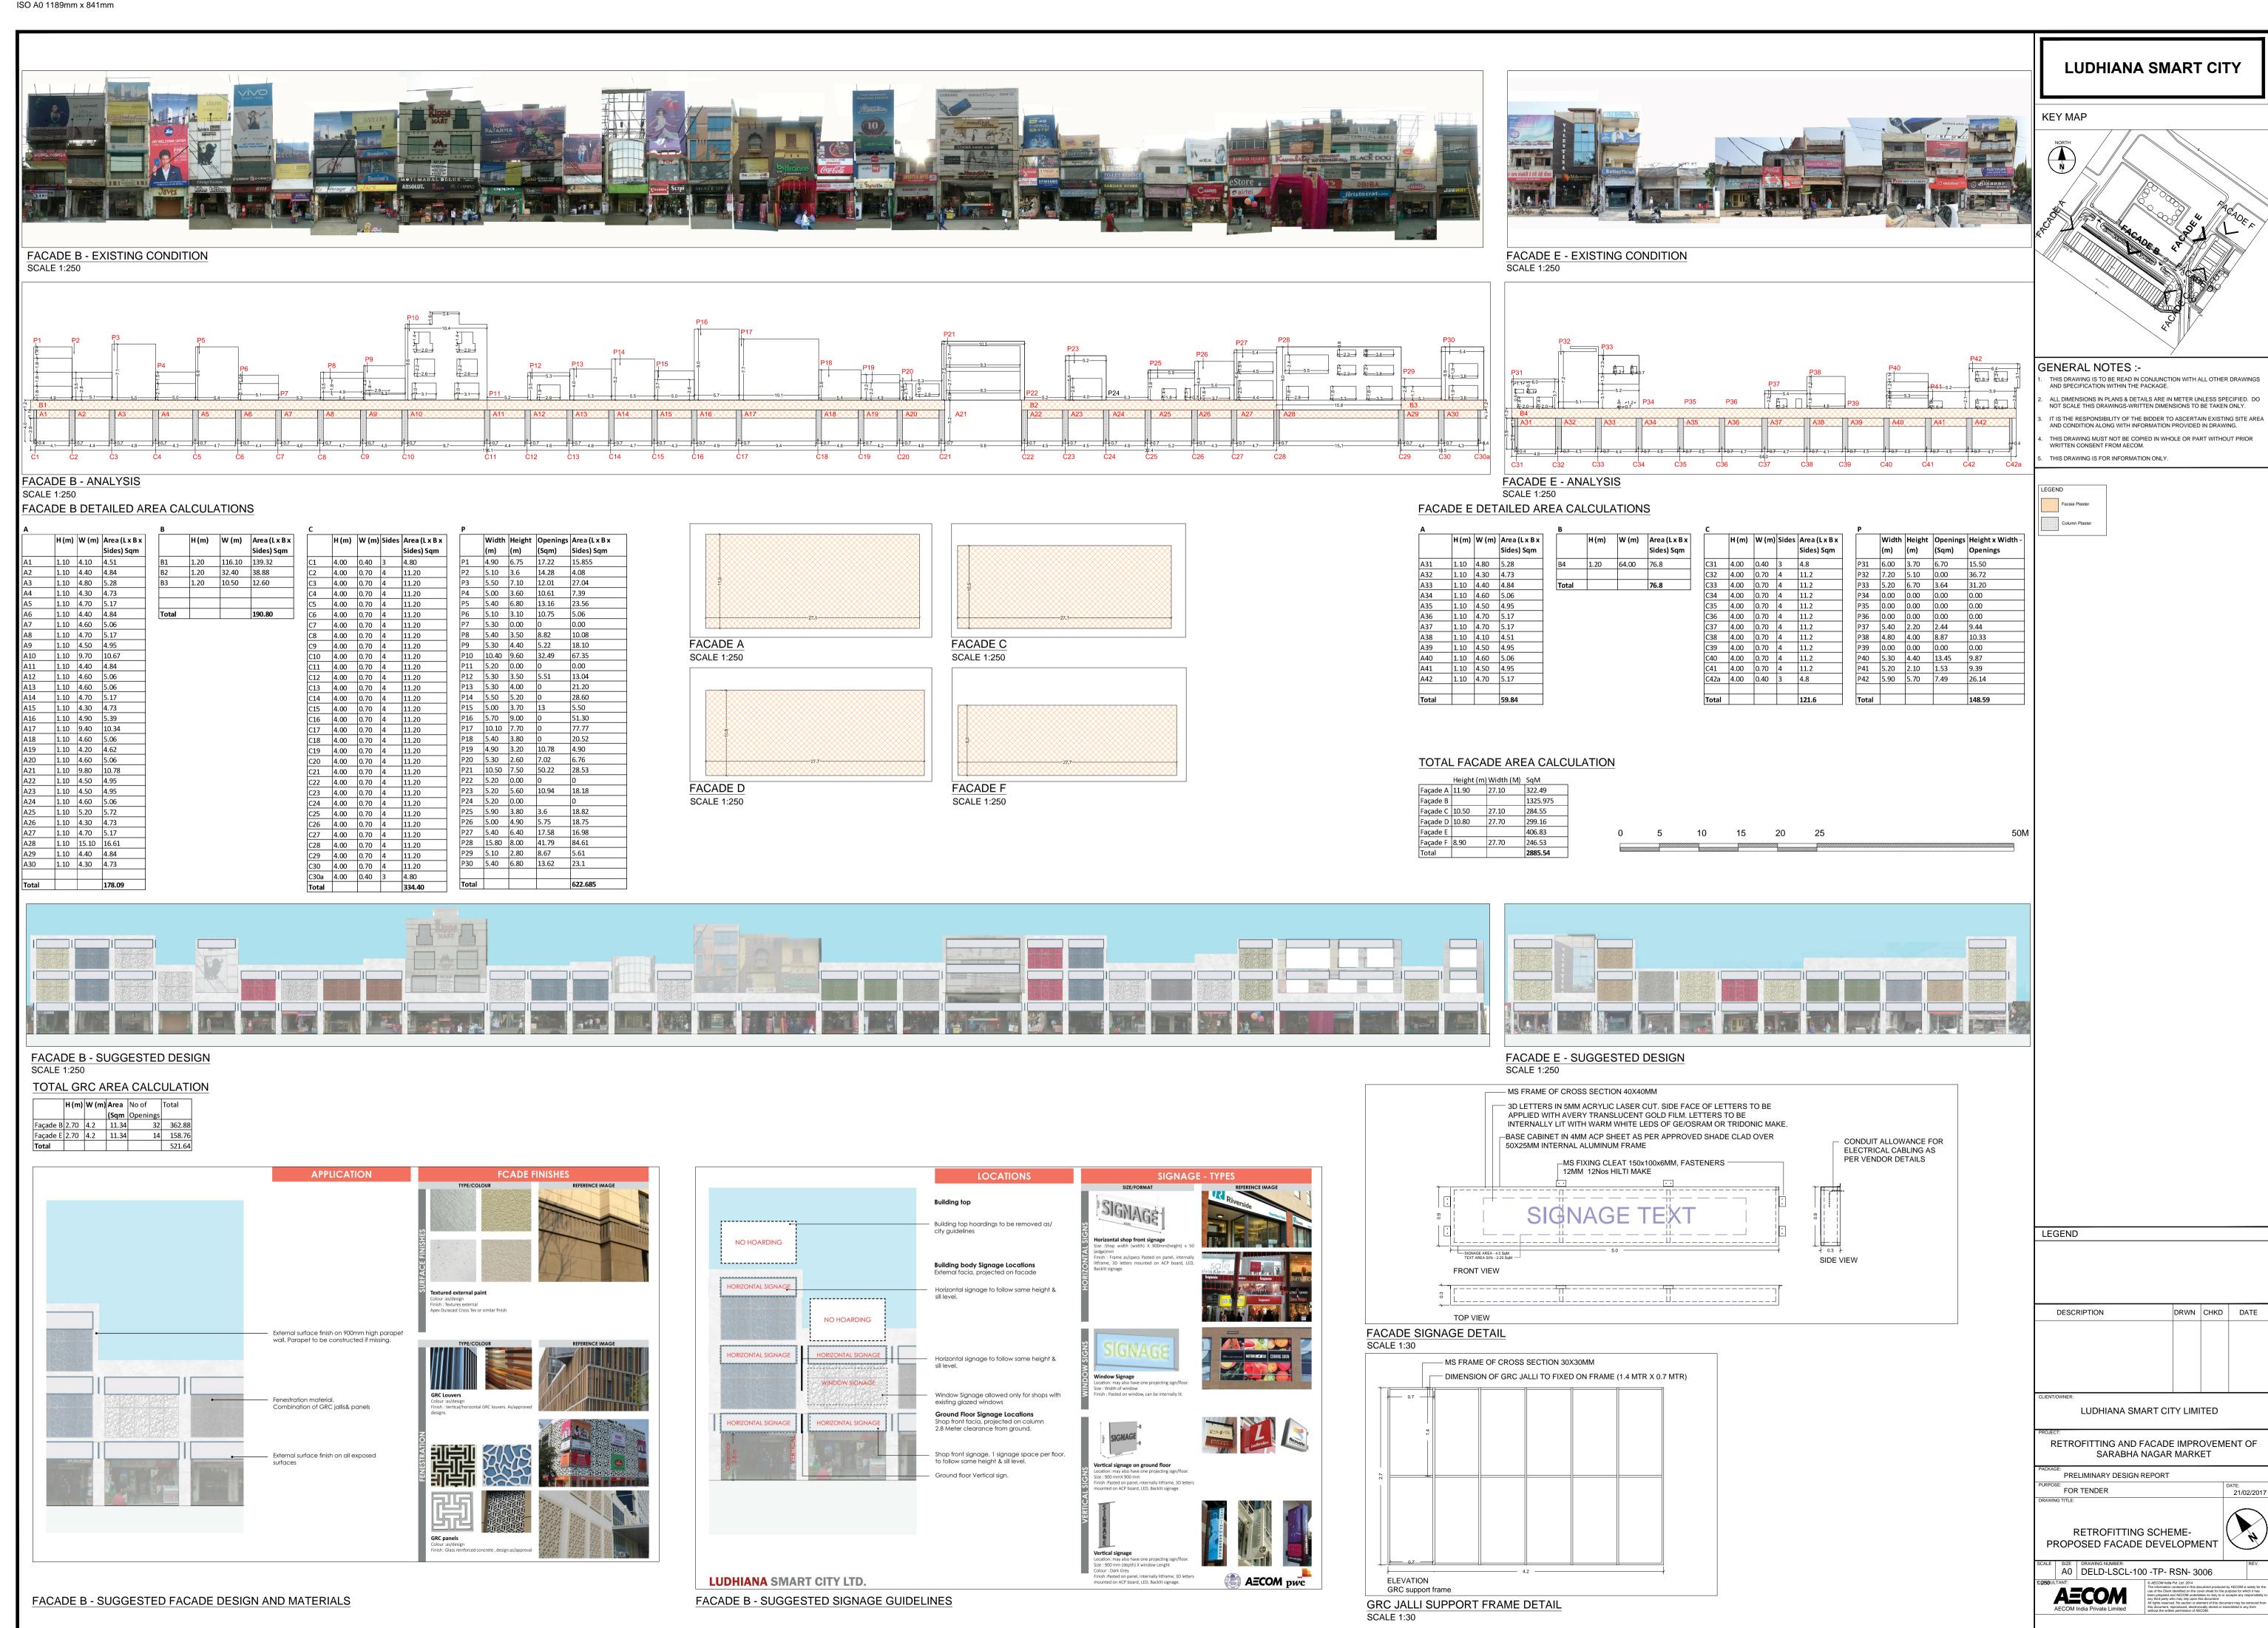


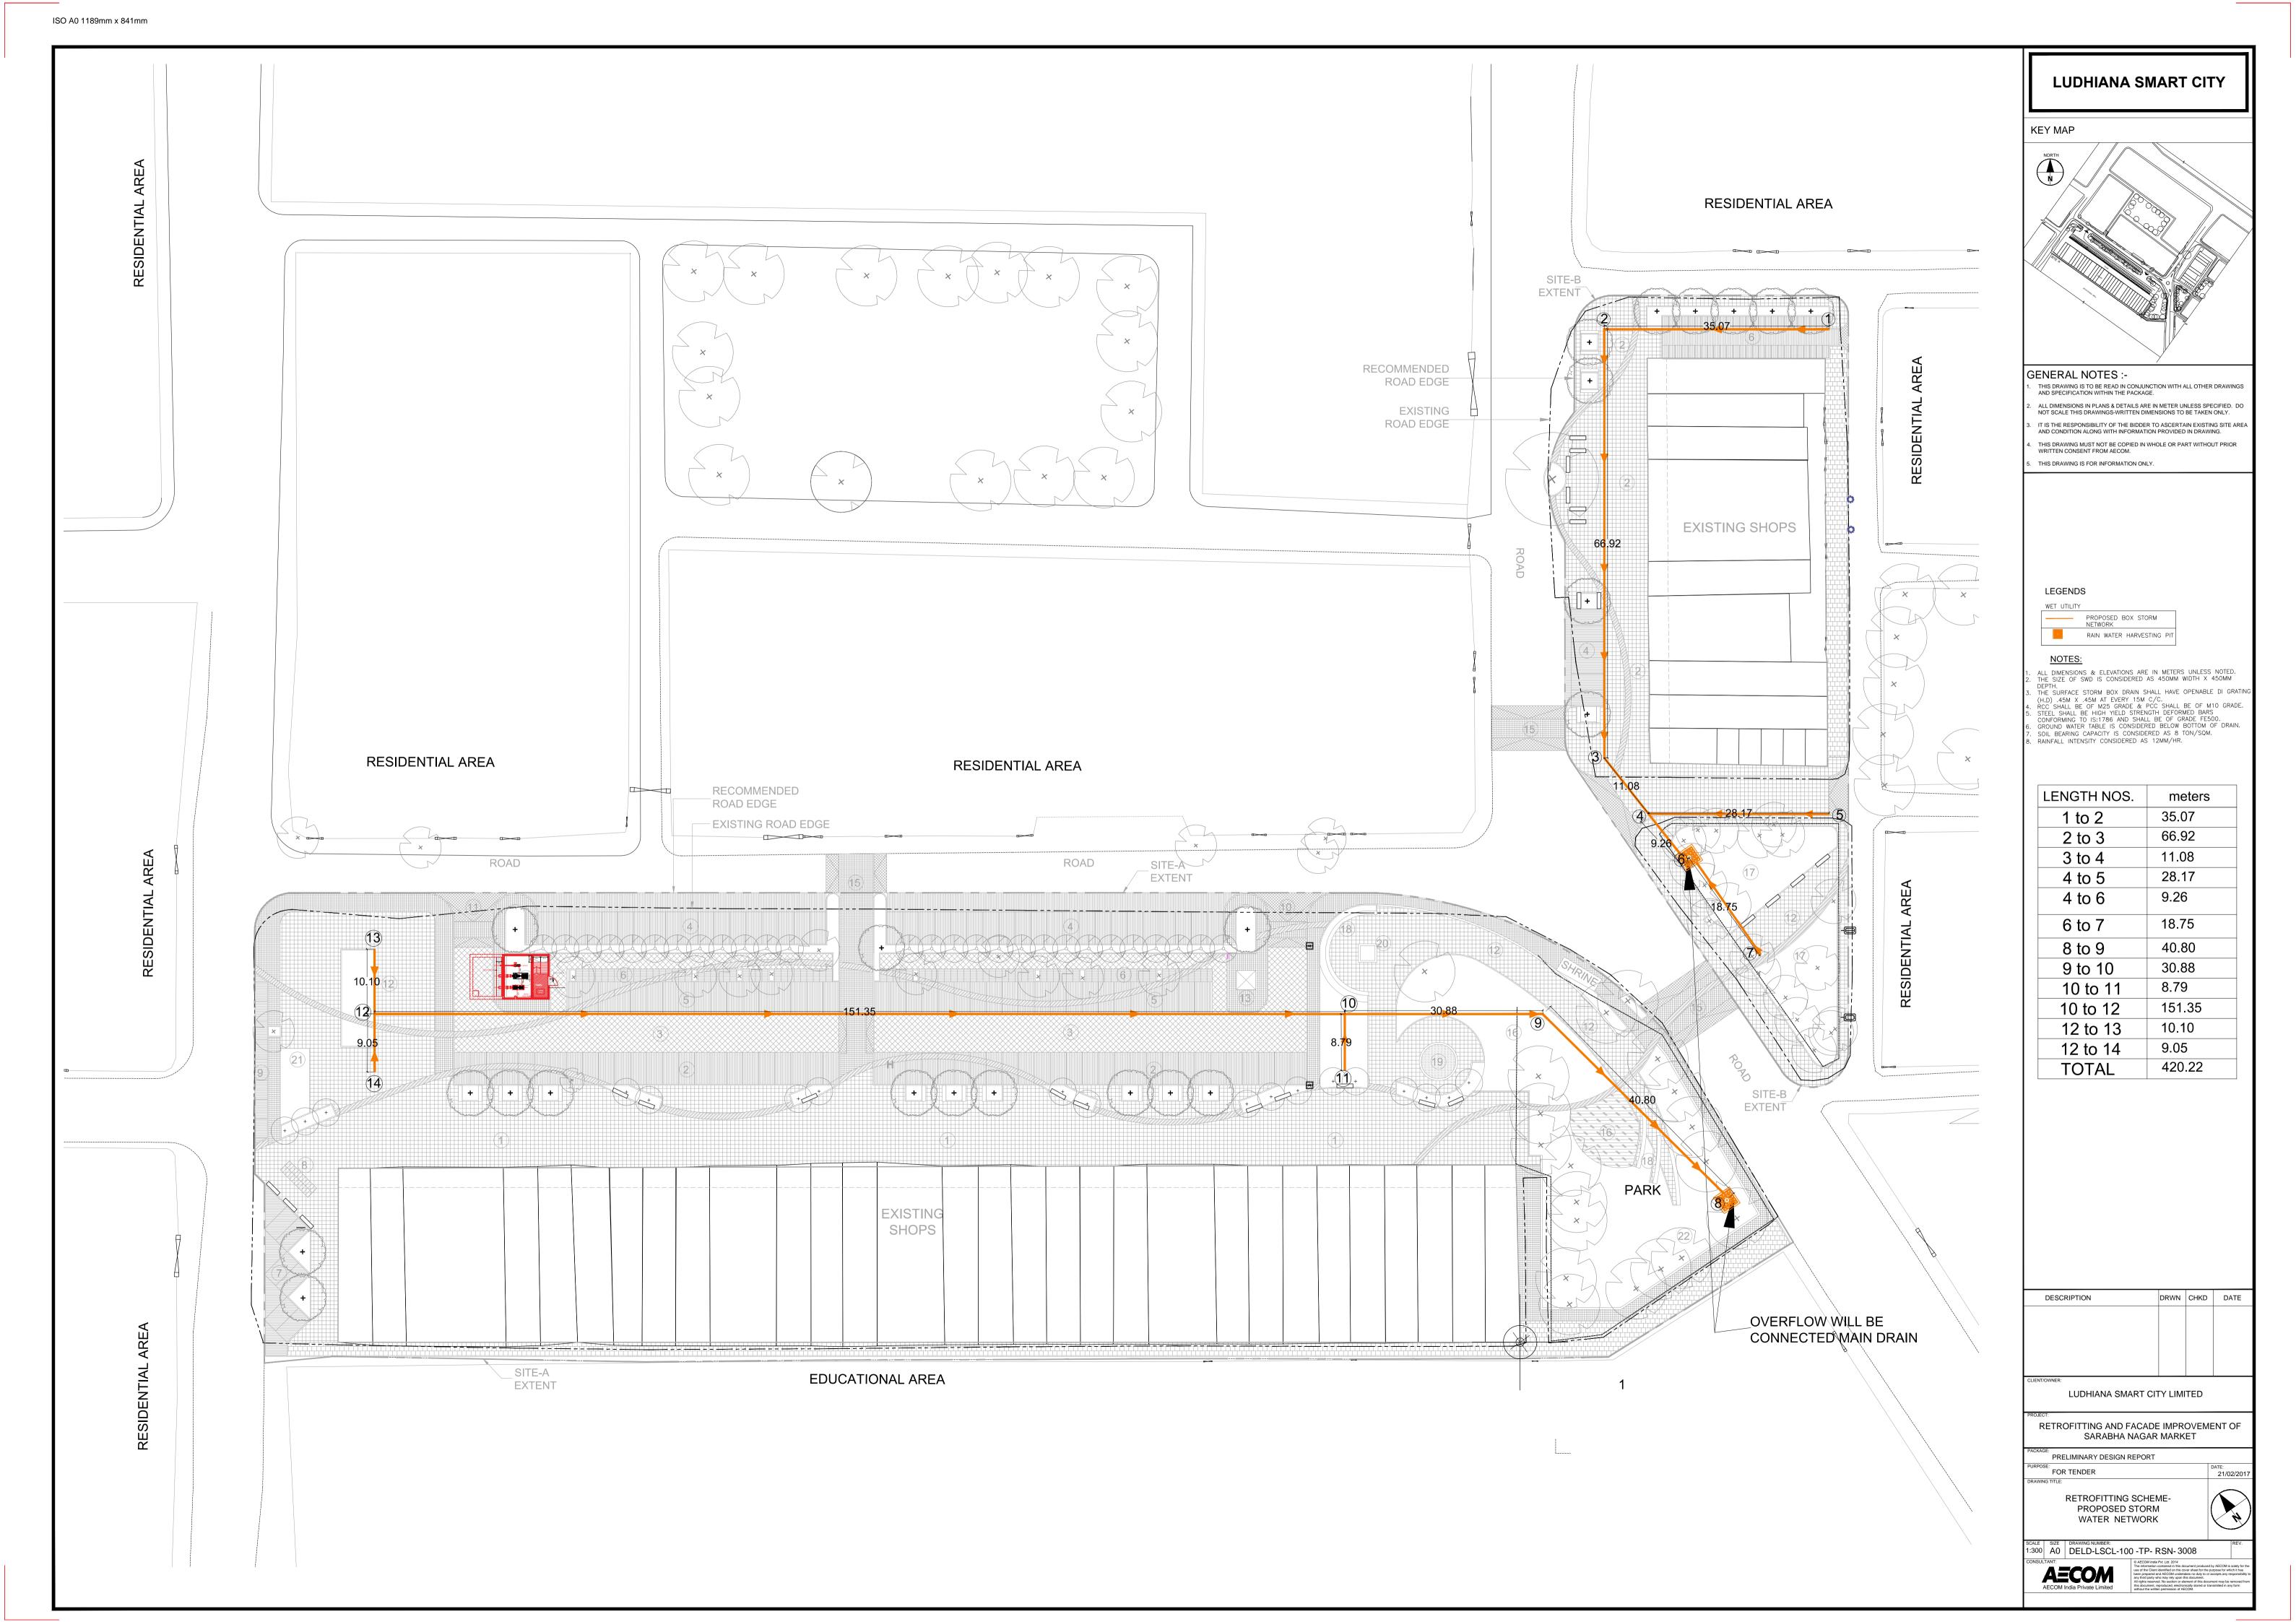

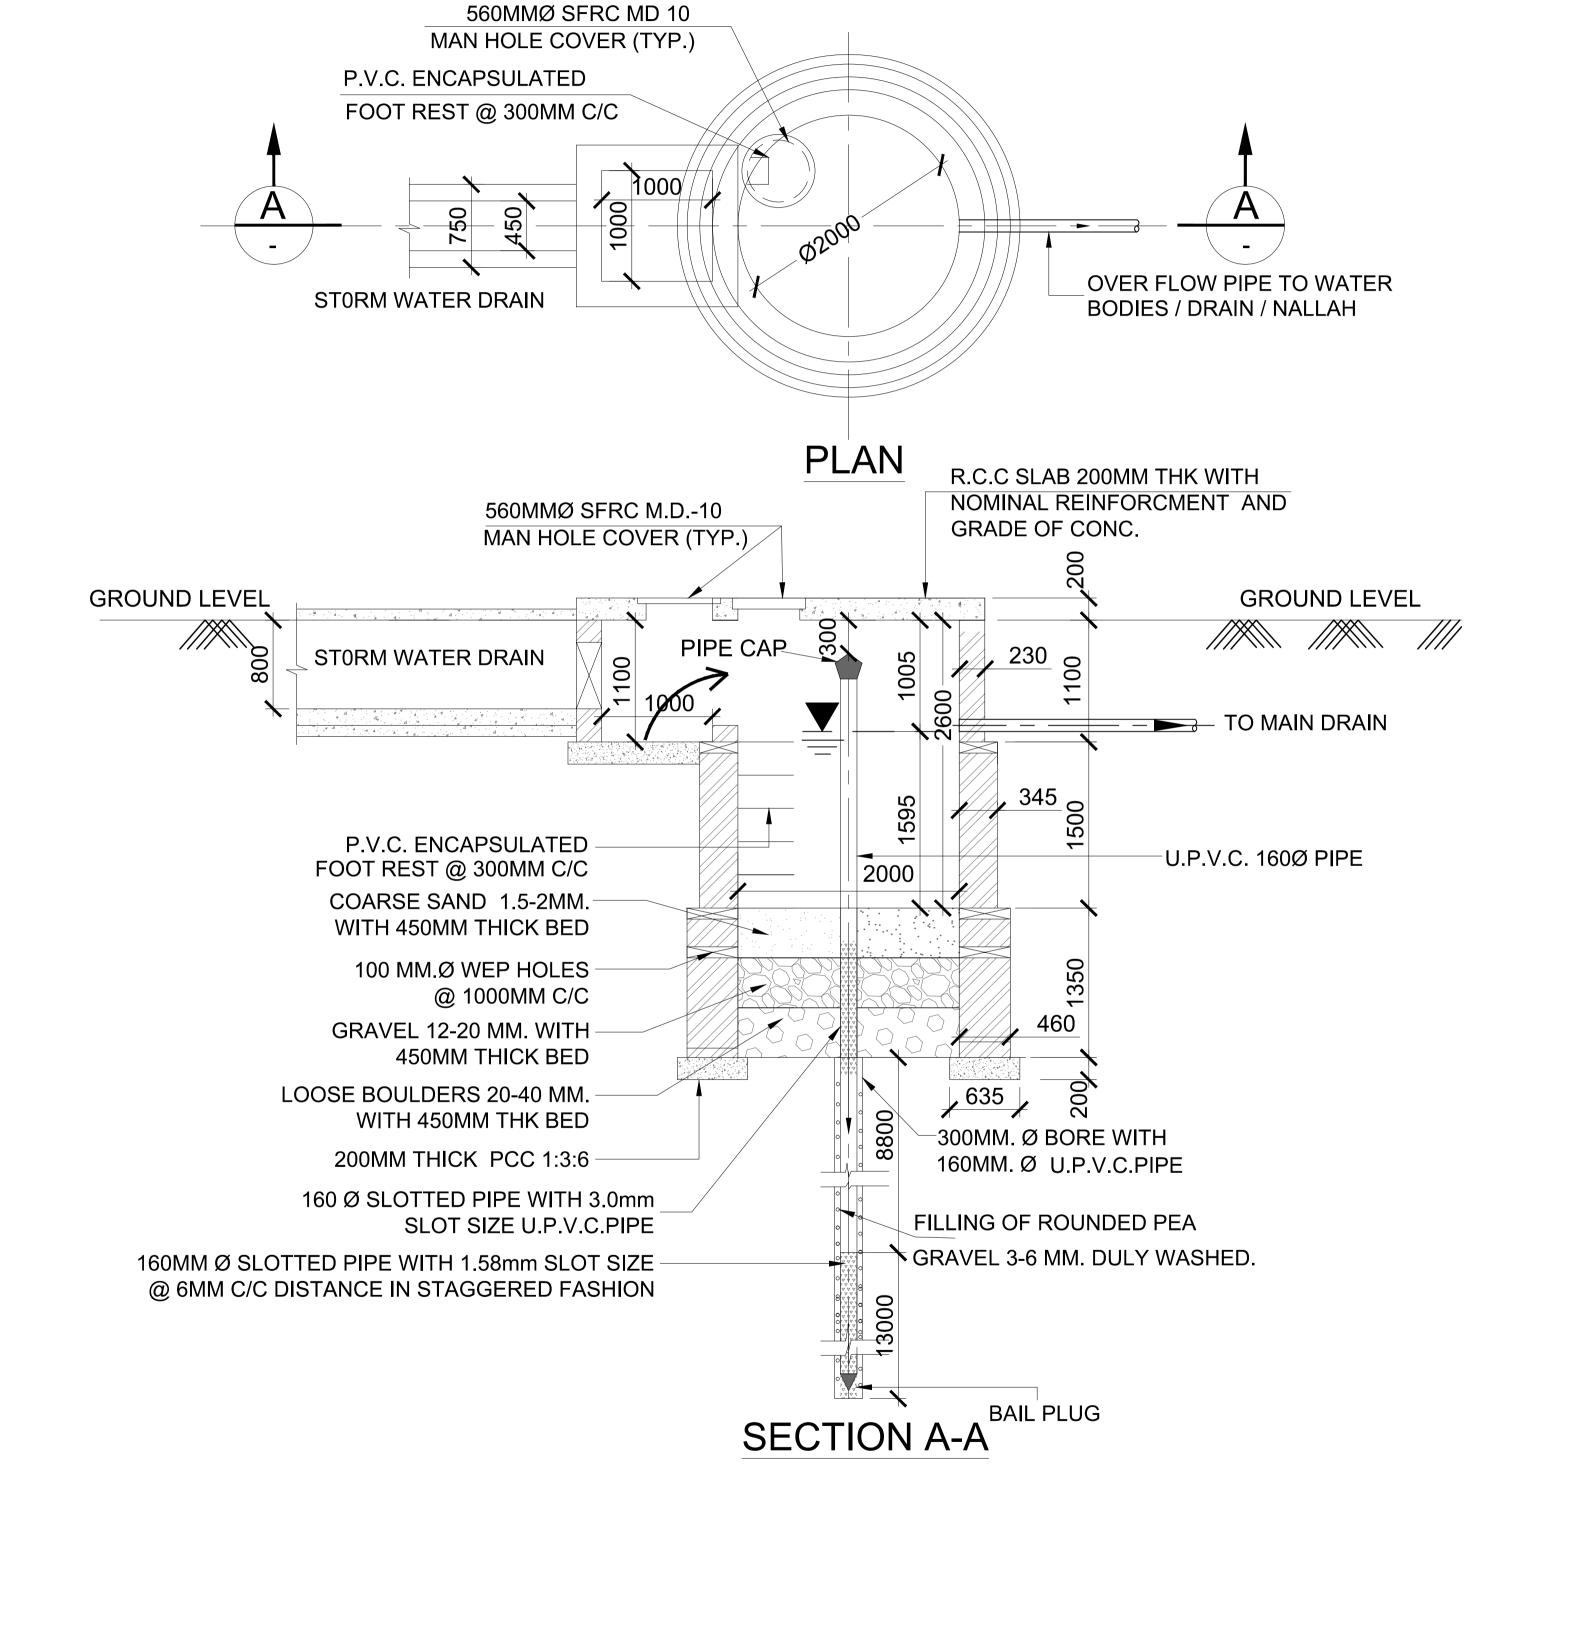

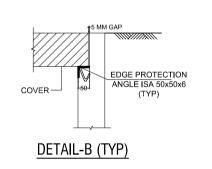


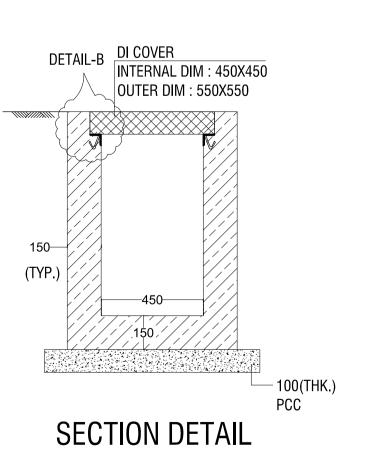

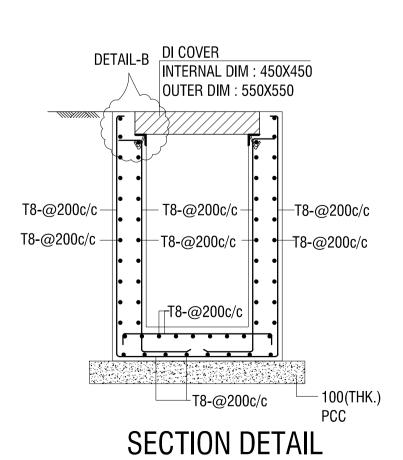

DETAIL-B (TYP)

LUDHIANA SMART CITY

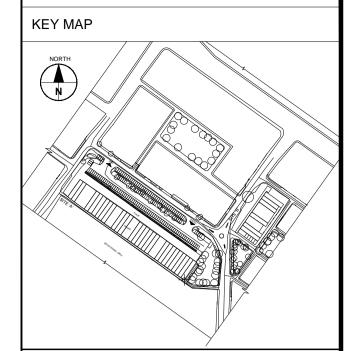

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NOTES:

1. ALL EARTH SURFACE UPON OR AGAINST CONCRETE IS TO BE PLACED SHALL BE WELL COMPACTED AND SHOULD BE FREE FROM STANDING WATER, MUD OR DEBRIS.

2. RCC SHALL BE OF M25 GRADE & PCC SHALL BE OF M10 GRADE.

3. GROUND WATER TABLE IS CONSIDERED BELOW BOTTOM OF DRAIN.

4. SOIL BEARING CAPACITY IS CONSIDERED AS 8 TON/SQM.

DESCRIPTION DRWN CHKD DATE

LUDHIANA SMART CITY LIMITED


RETROFITTING AND FACADE IMPROVEMENT OF SARABHA NAGAR MARKET


PRELIMINARY DESIGN REPORT


FOR TENDER


RETROFITTING SCHEME: PROPOSED RWHP AND STORM WATER DRAIN DETAILS

icale | Size | DRAWING NUMBER: | 1:300 | A0 | DELD-LSCL-100 -TP- RSN- 3009

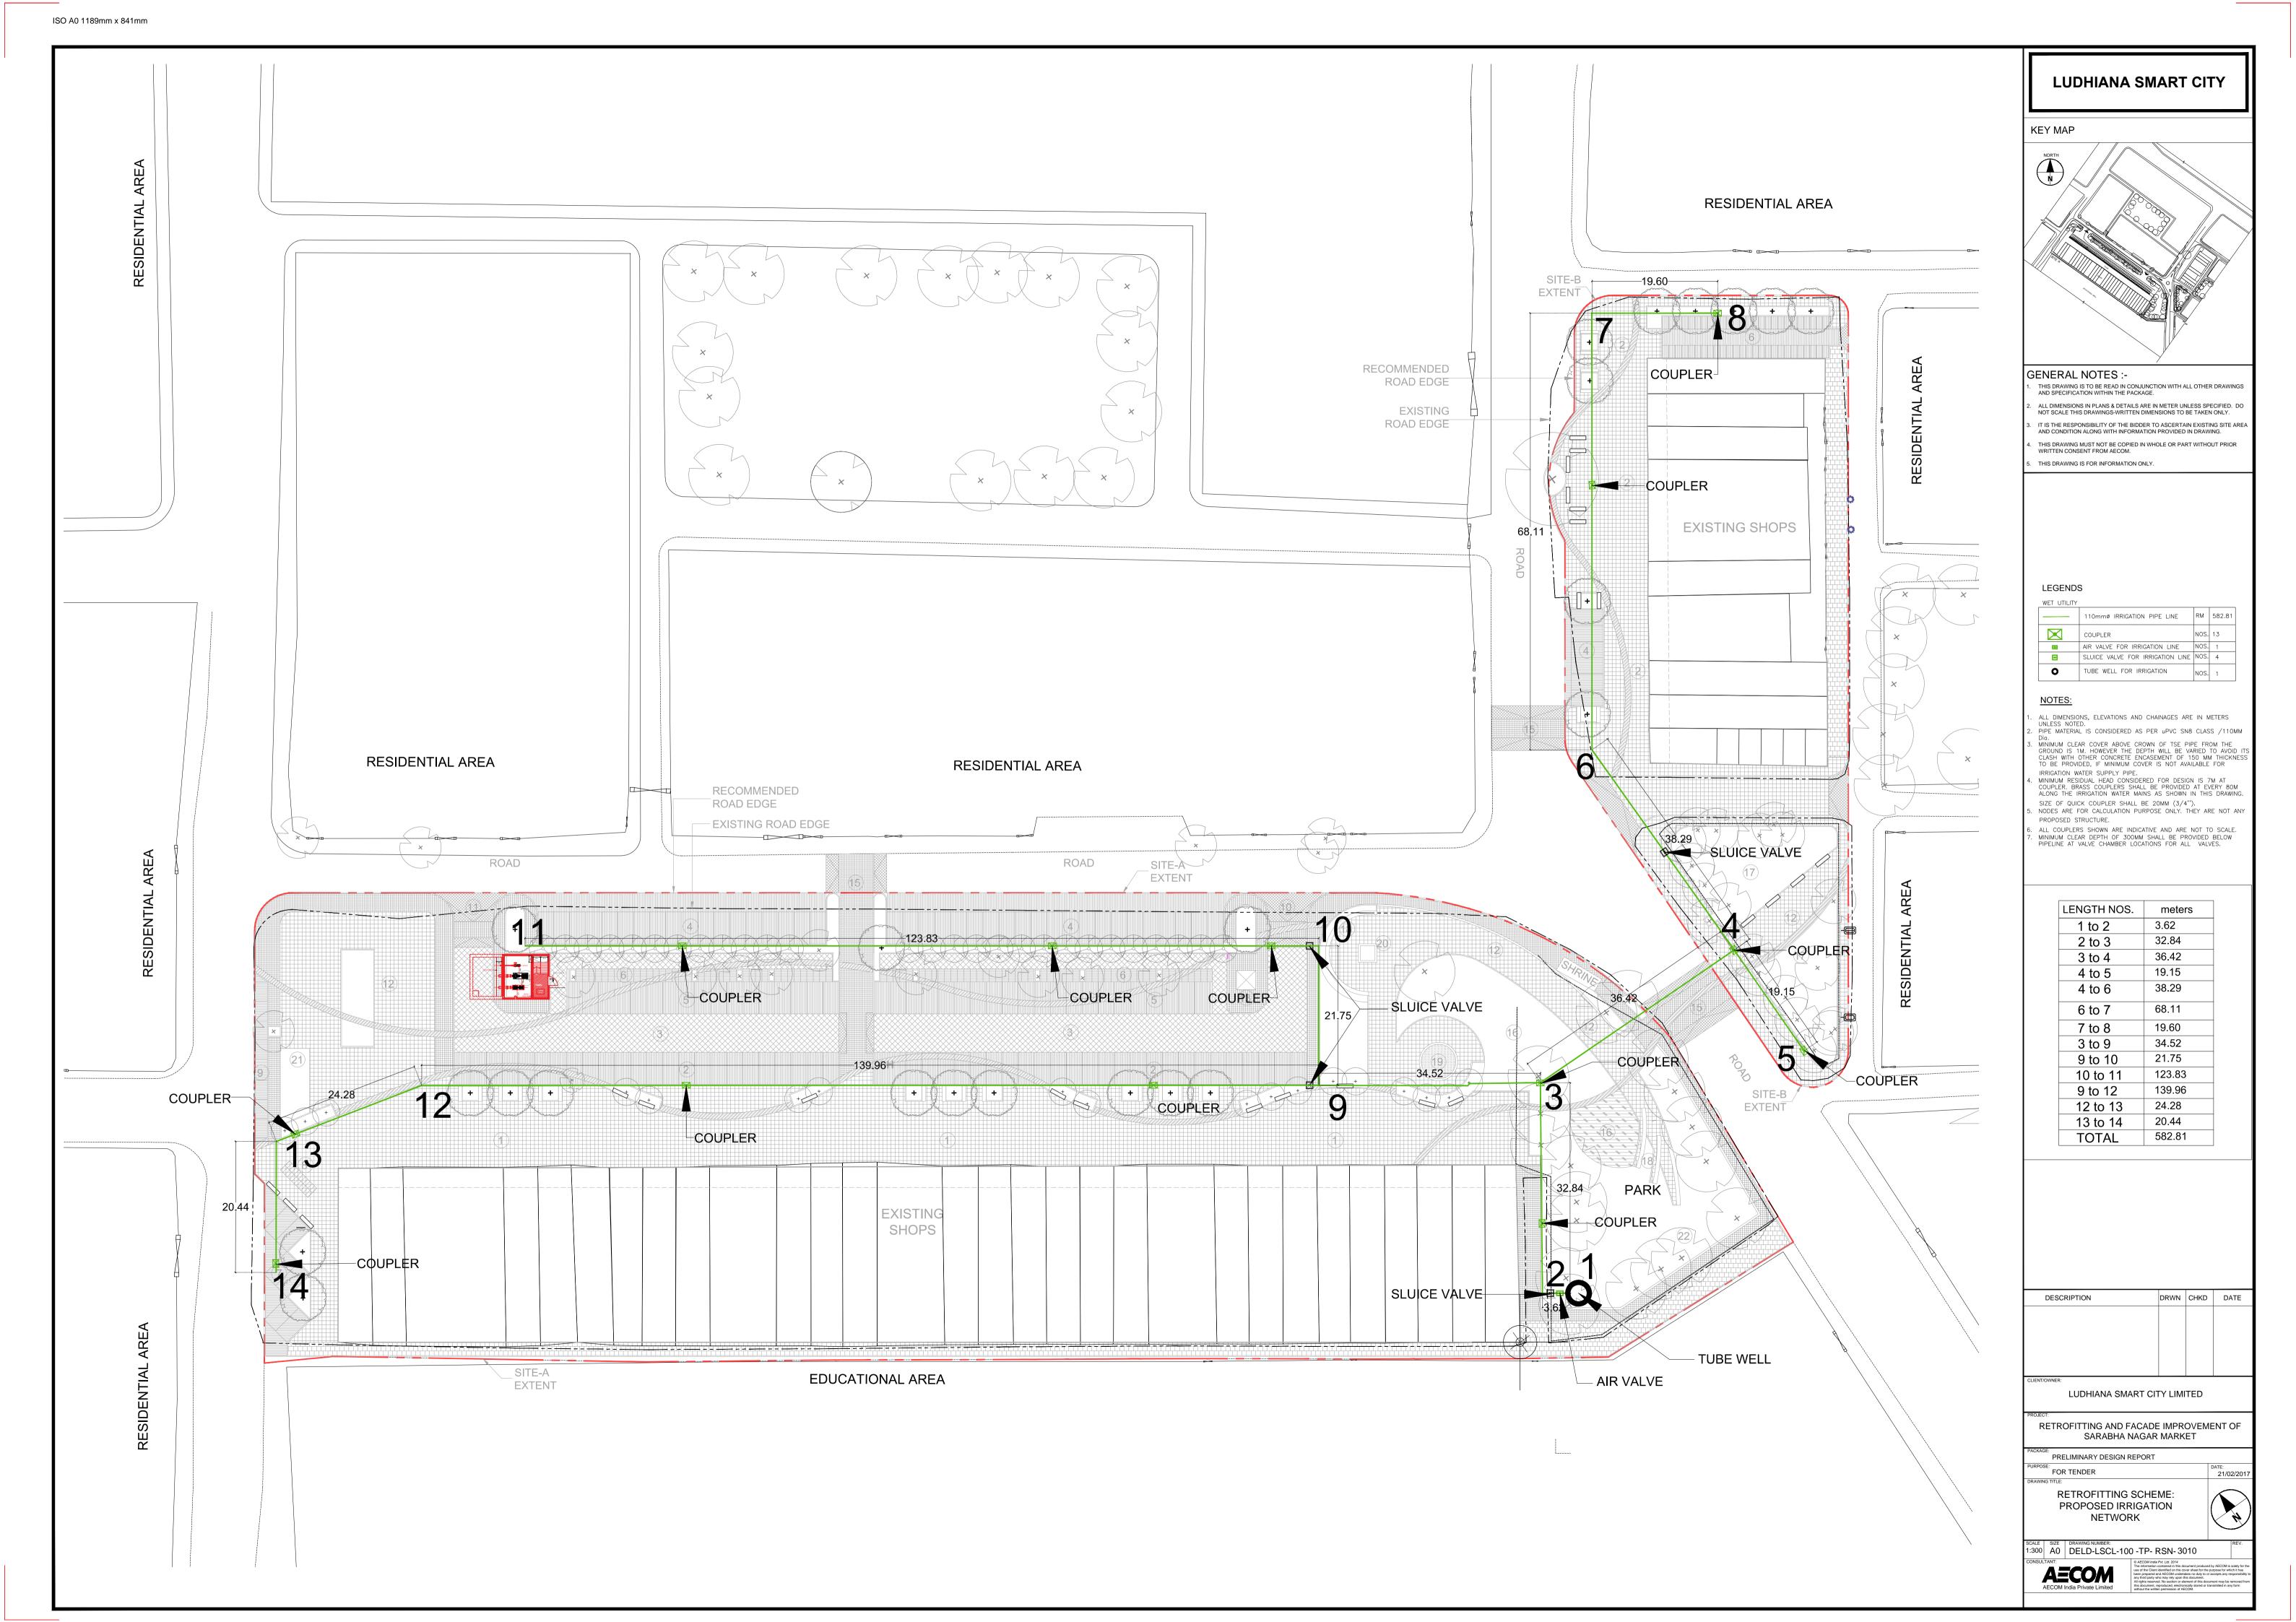


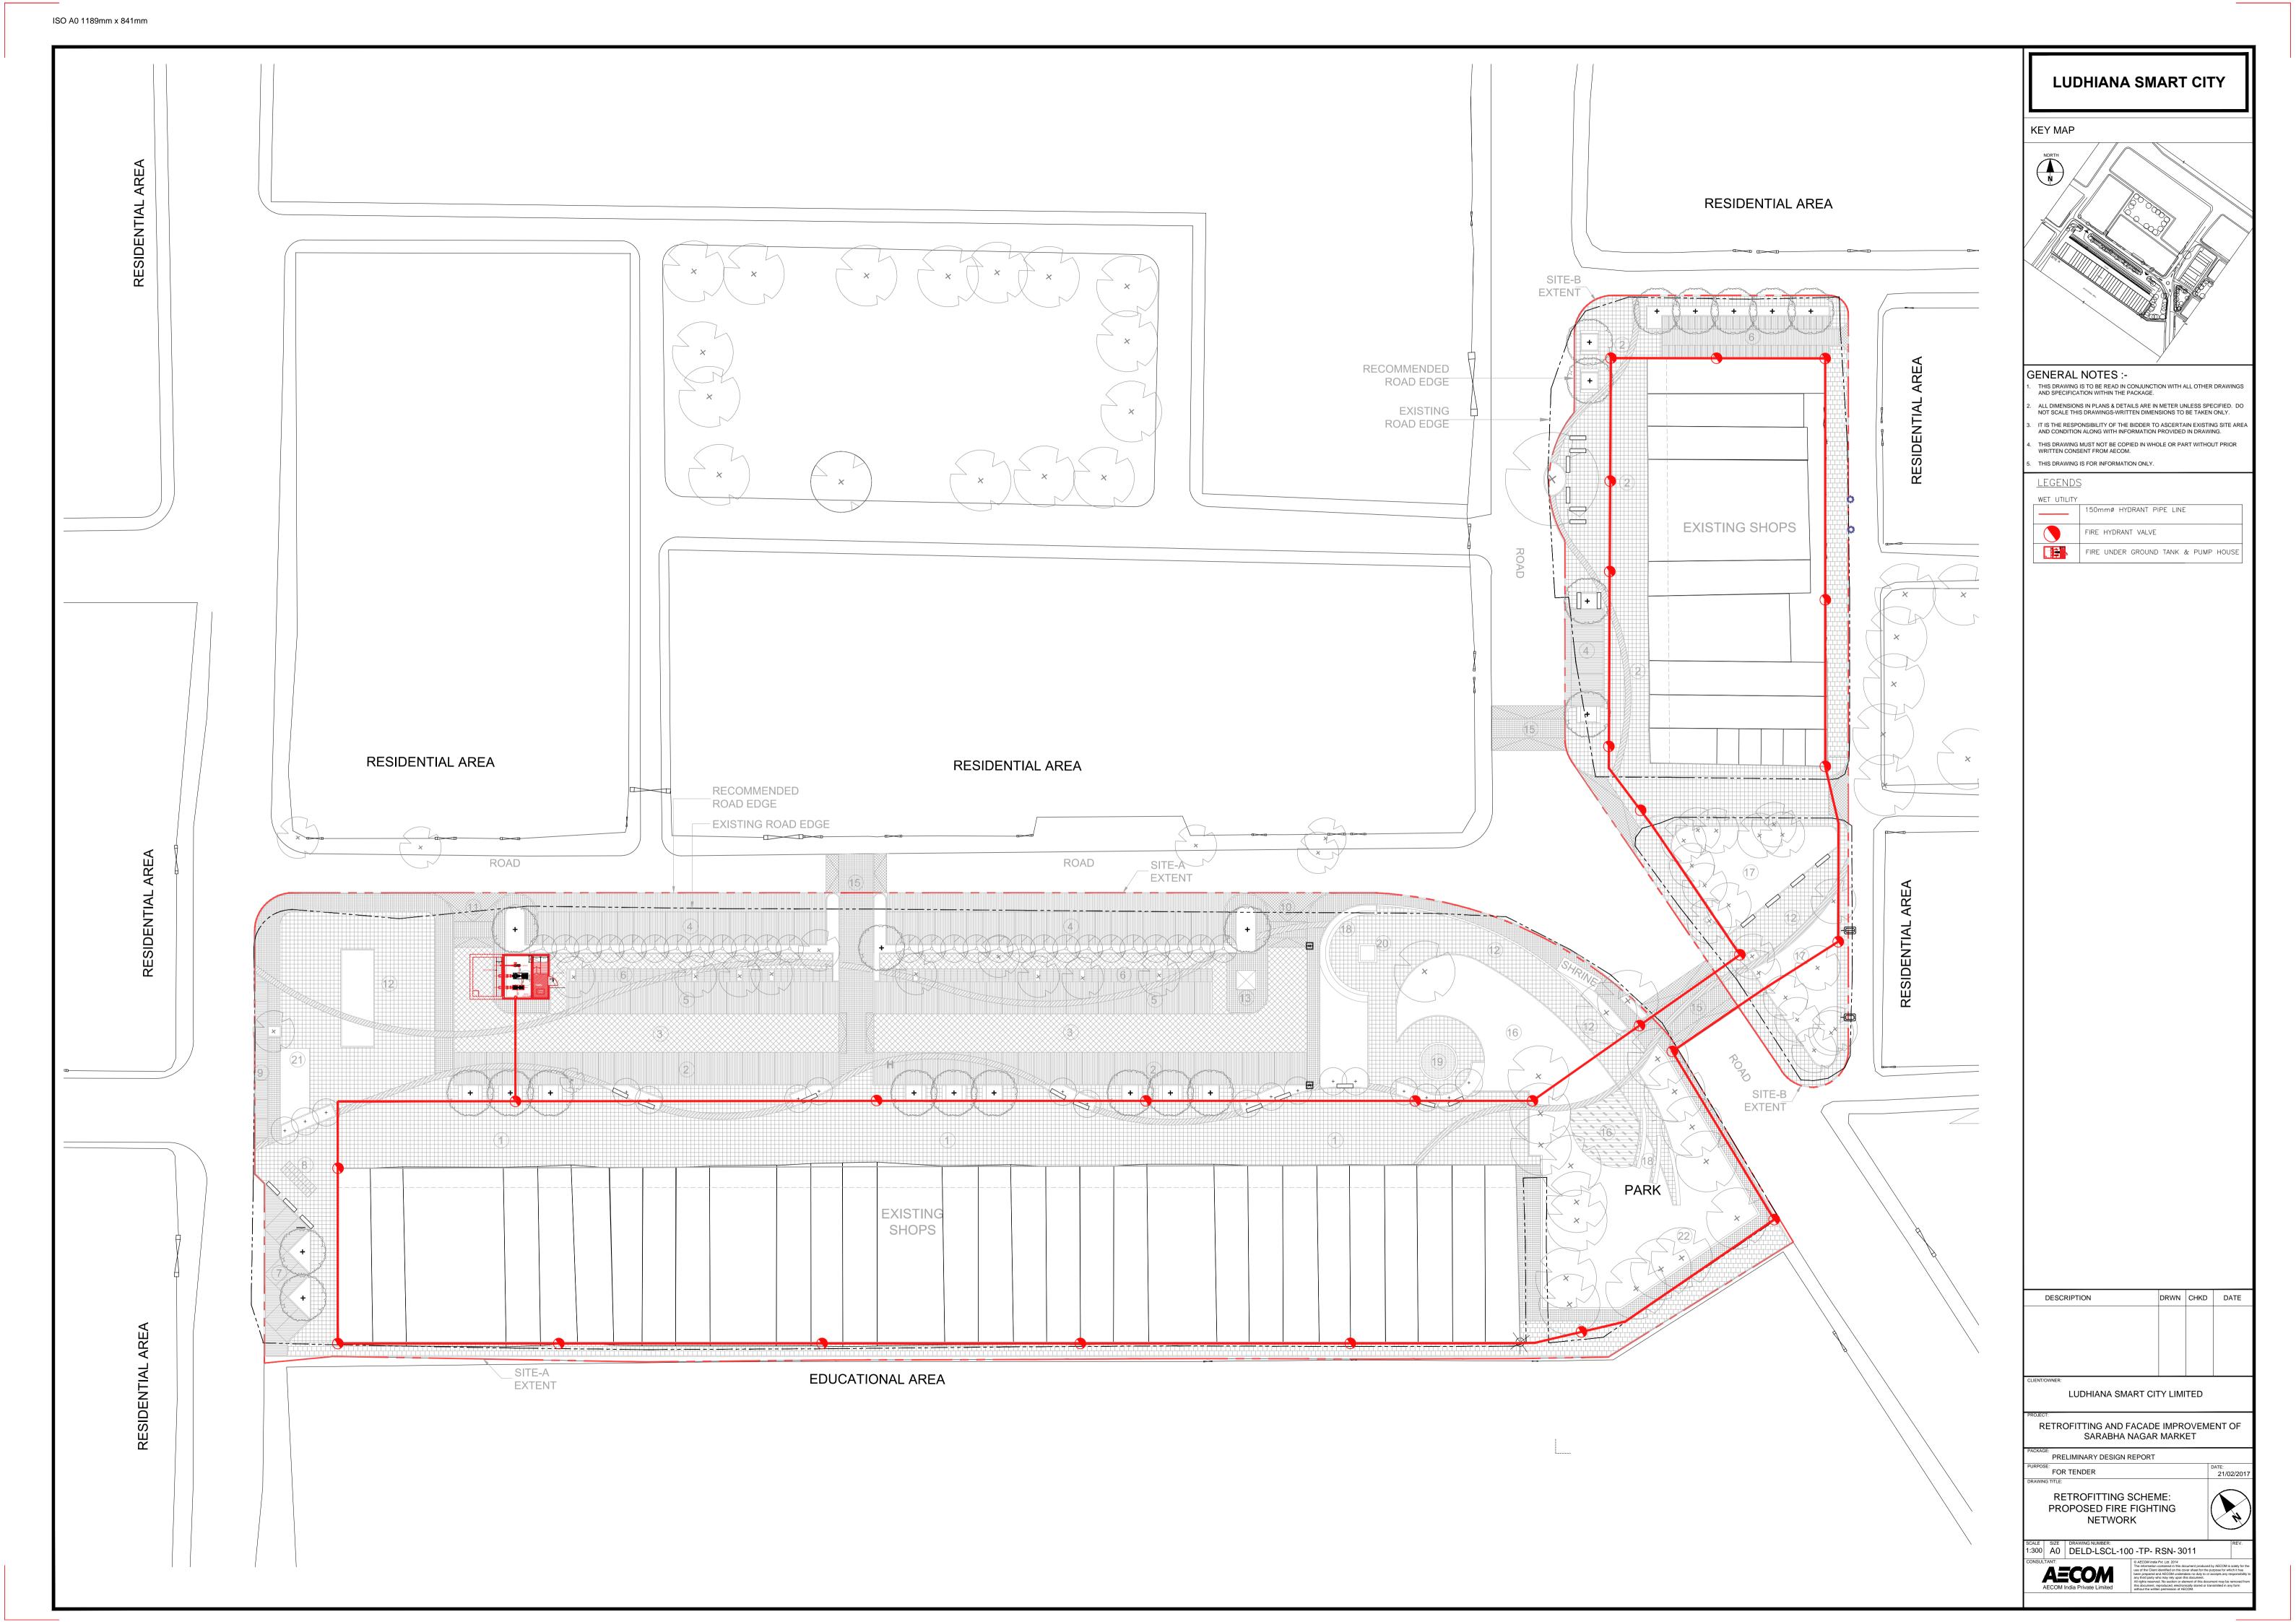

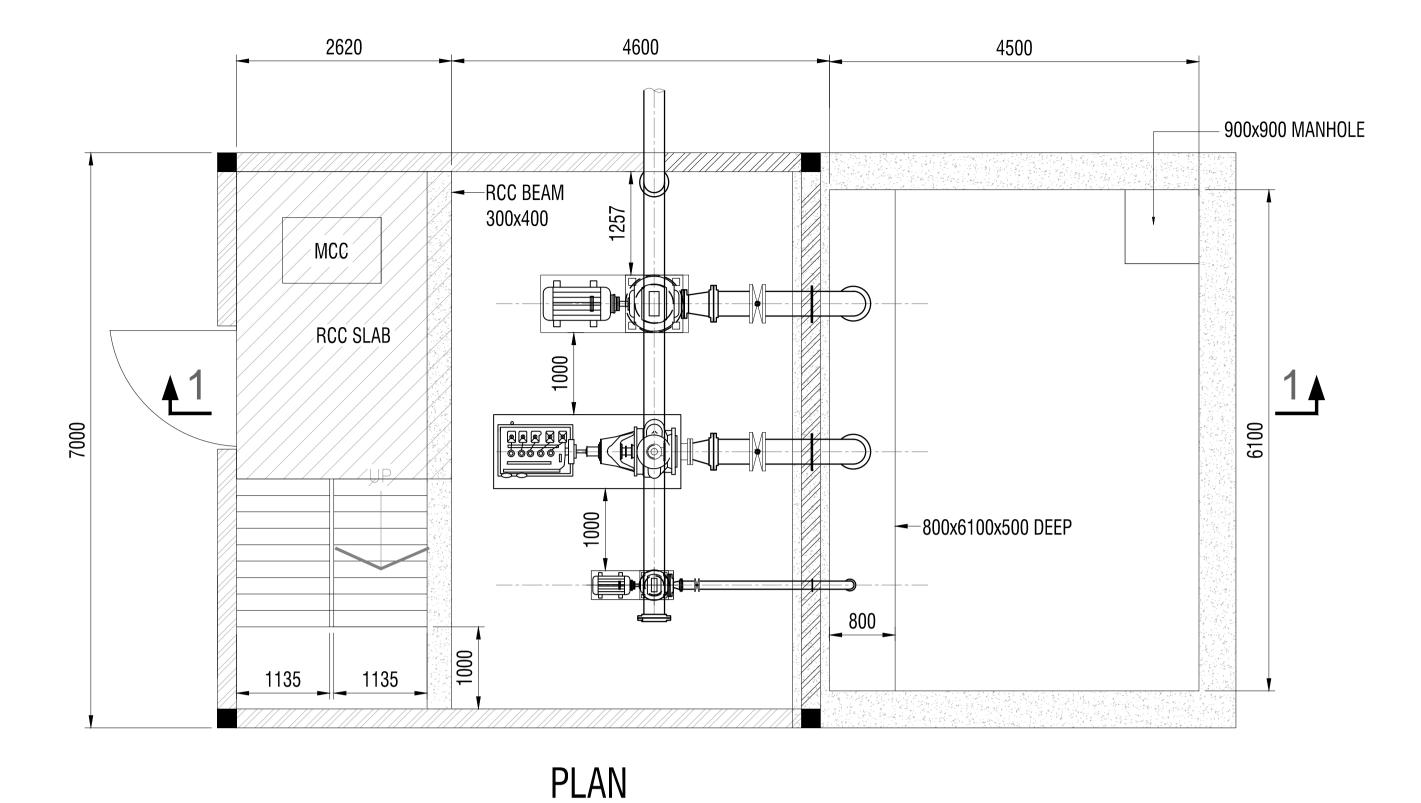

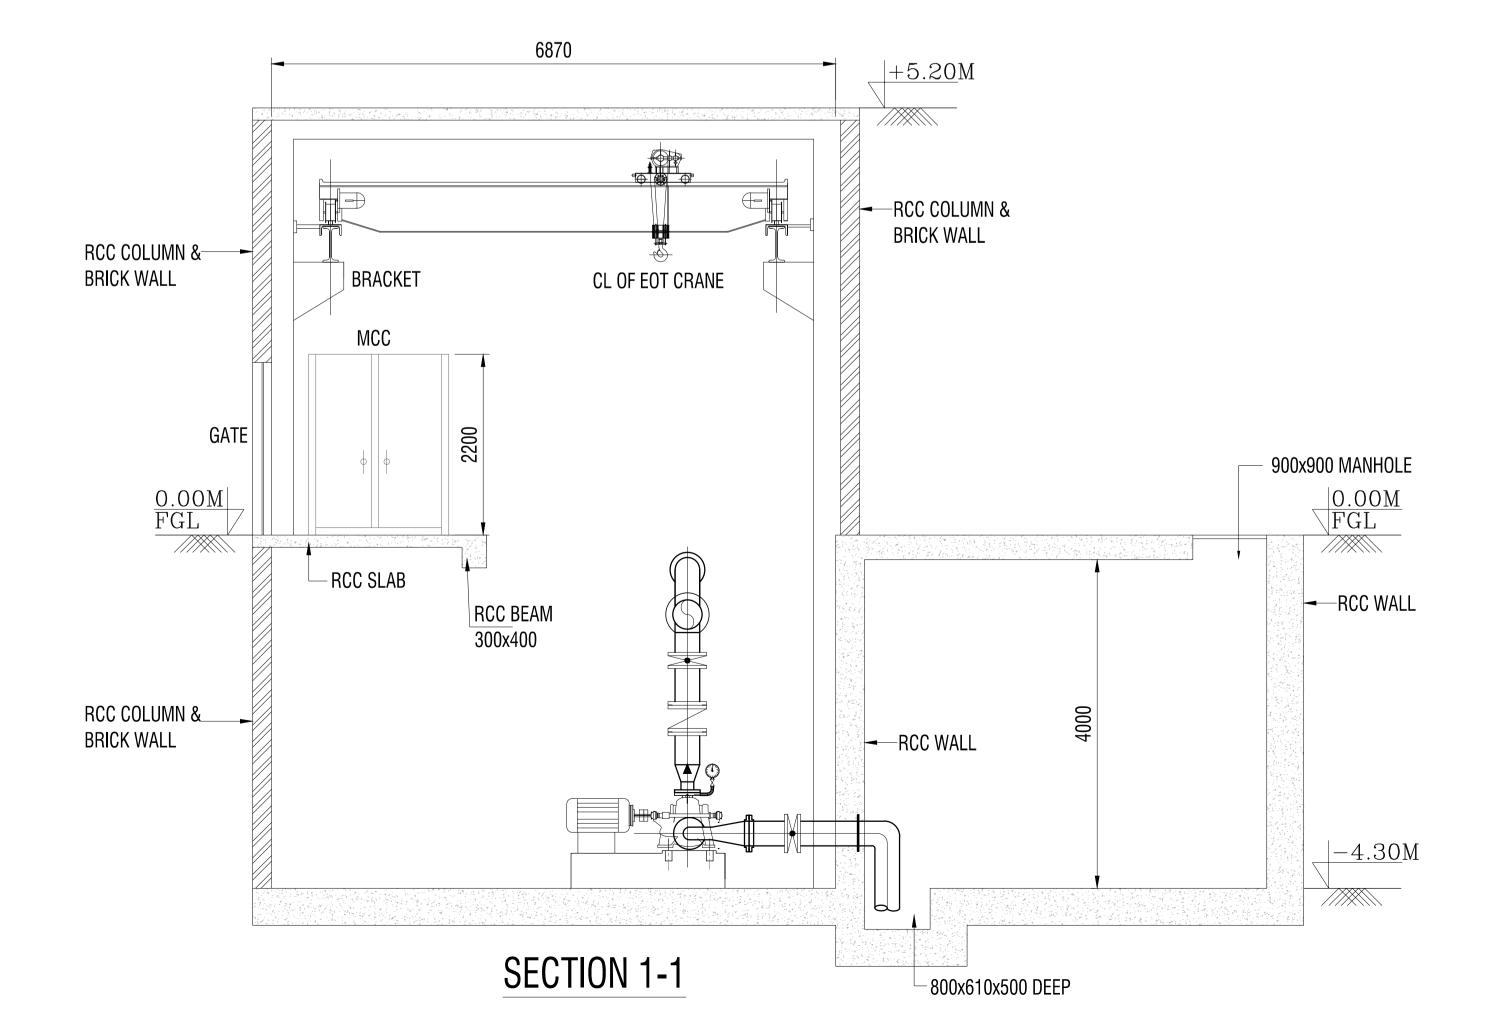

KEY MAP

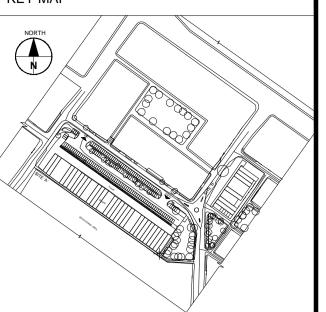

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NOTES:

- 1. ALL DIMENSIONS ARE IN MM AND LEVELS ARE IN M, UNLESS OTHERWISE SPECIFIED.
 - 2. THIS DRAWING SHALL BE MODIFIED BASED ON THE
 - DETAILED DESIGN FROM DBO CONTRACTOR. 3. LAYOUT DIMENSIONS ARE TENTATIVE. BIDDER HAS TO ASSESS THE PUMP HOUSE DIMENSION BASED ON
 - SELECTION OF PUMPS & ELECTRO- MECHANICAL EQUIPMENTS. 4. BUTTERFLY VALVE SHALL BE CONFORMING TO IS:
 - 13095/AWWA C504 AND NON RETURN VALVE SHALL BE CONFORMING TO AWWA C508. 5. ALL REDUCERS IN THE SUCTION SIDE ARE ECCENTRIC
 - TYPE WITH FLAT SIDE UP (FSU) AND CONCENTRIC TYPE FOR DISCHARGE SIDE.
 - 6. THE MATCHING FLANGES OF THE SUCTION & DELIVERY PIPELINES SHALL BE MATCH WITH THE PUMPS FLANGES.
 - (AS PER PUMP SUPPLIERS DRAWINGS) 7. ALL PIPING SHALL BE M.S BLACK ERW HEAVY GRADE PIPING
 - AS PER IS: 1239 /IS: 3589 8. THE MECHANICAL EQUIPMENTS / FOUNDATIONS SHOWN
 - HERE ARE TENTATIVE, SHALL BE FINALISE.
 - 9. THE LEVELS ARE TENTATIVE AND ARE BASED ON FGL +0.00M.

DESCRIPTION DRWN CHKD DATE

LUDHIANA SMART CITY LIMITED

RETROFITTING AND FACADE IMPROVEMENT OF SARABHA NAGAR MARKET

PRELIMINARY DESIGN REPORT

FOR TENDER RETROFITTING SCHEME:

PROPOSED FIRE FIGHTING
RESERVOIR & PUMP HOUSE DETAIL

A0 DELD-LSCL-100 -TP- RSN-3012



DESCRIPTION DRWN CHKD DATE

LUDHIANA SMART CITY LIMITED

RETROFITTING AND FACADE IMPROVEMENT OF SARABHA NAGAR MARKET

PRELIMINARY DESIGN REPORT

POSE: FOR TENDER MING TITLE:

RETROFITTING SCHEME EXISTING POWER DISTRIBUTION

SCALE SIZE DRAWING NUMBER:
A0 DELD-LSCL-100 -TP- RSN- 3013


SULTANT:


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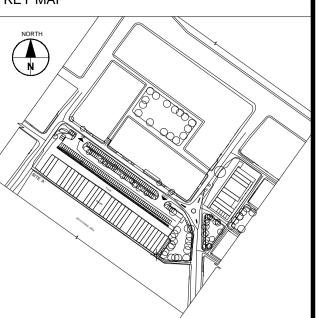
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KEY MAP



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LUDHIANA SMART CITY LIMITED

RETROFITTING AND FACADE IMPROVEMENT OF SARABHA NAGAR MARKET

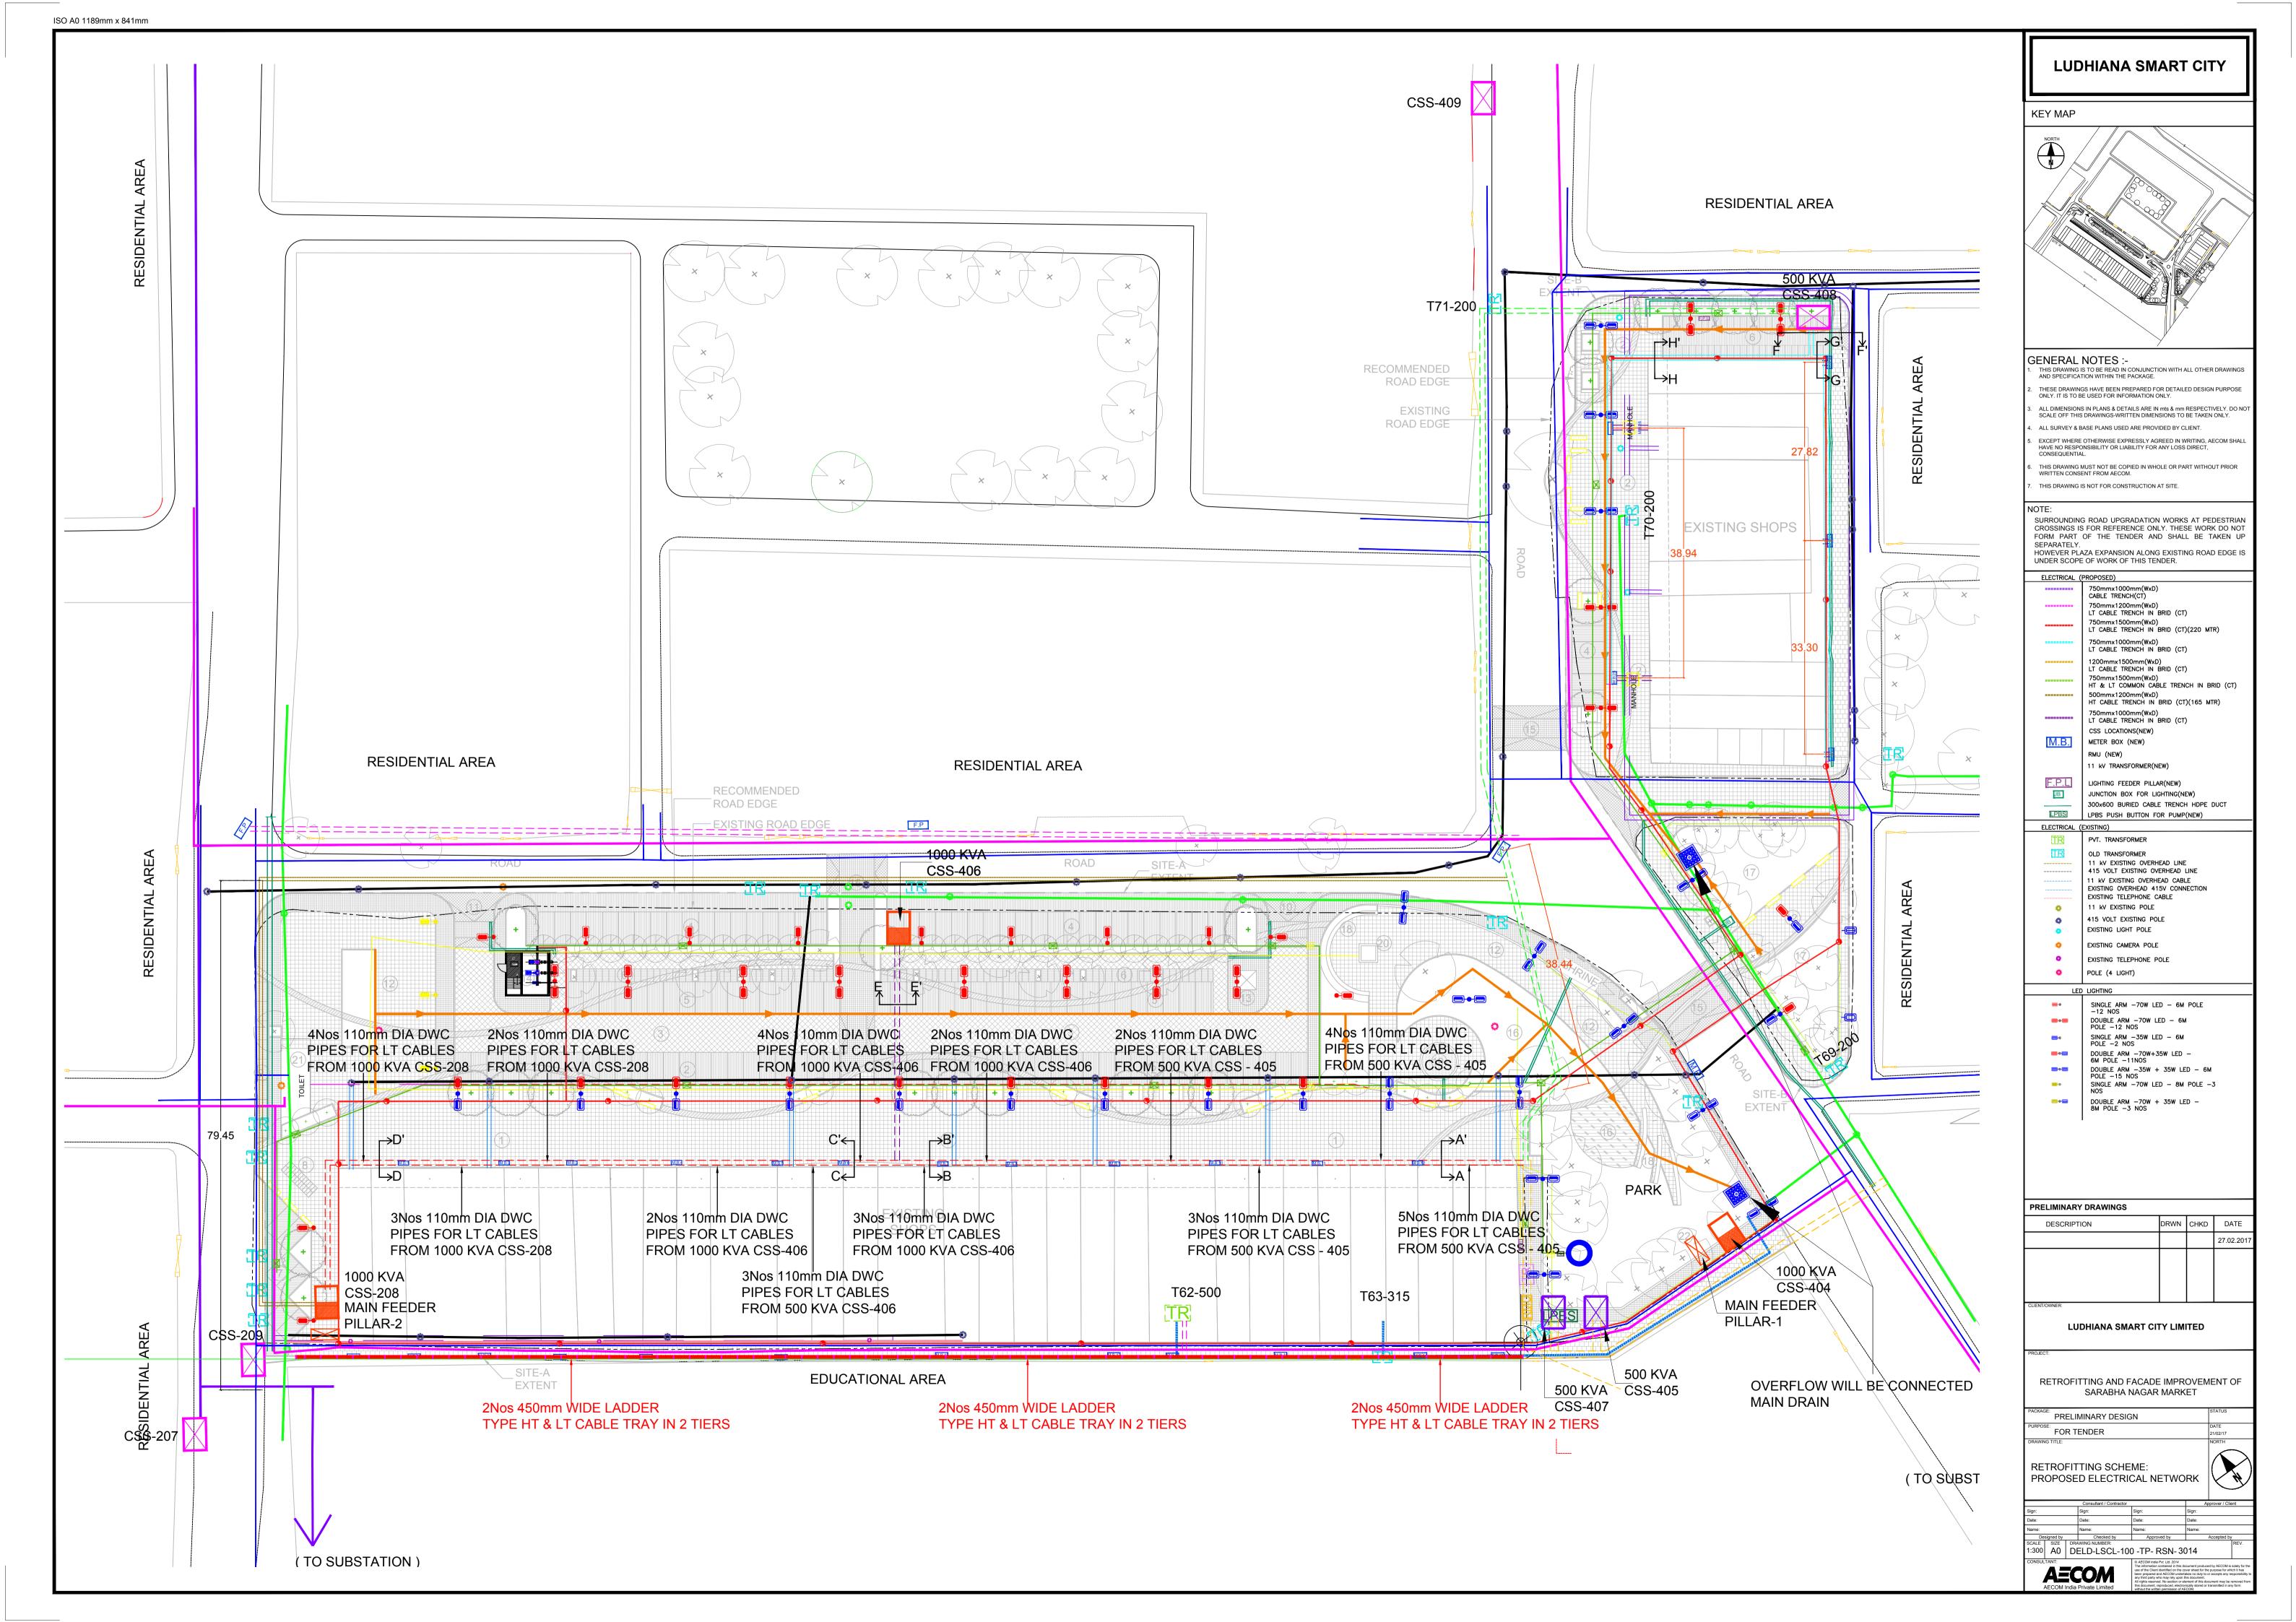PRELIMINARY DESIGN REPORT

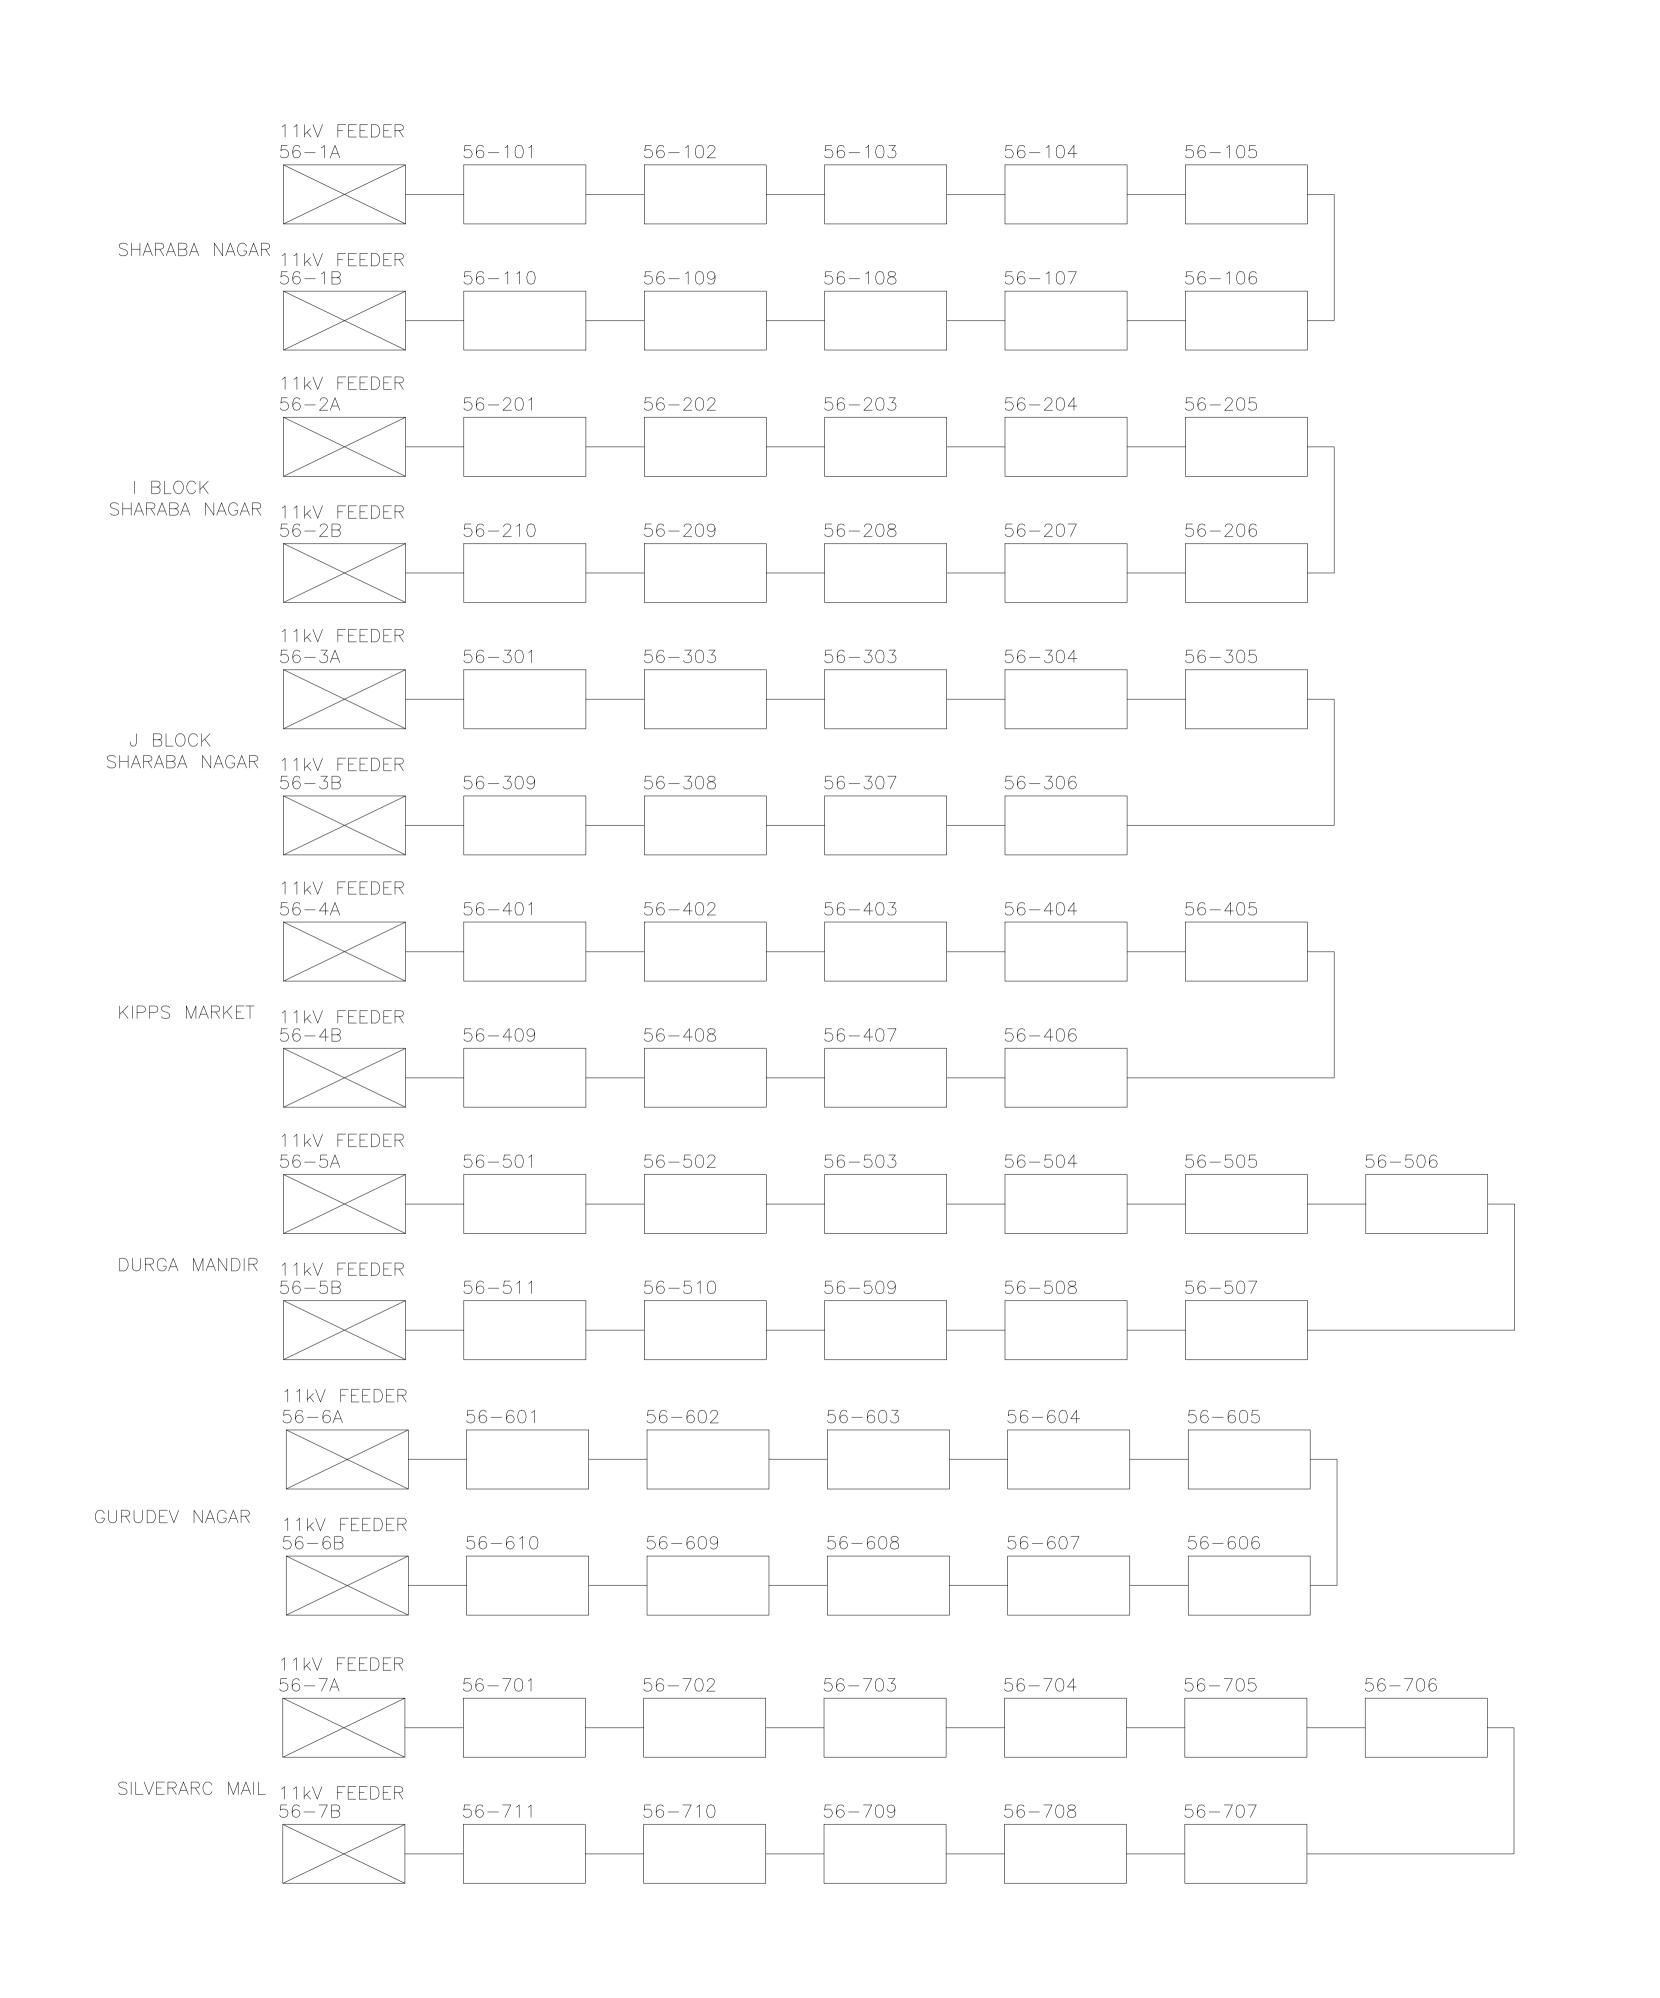PURPOSE:
FOR TENDER

RETROFITTING SCHEME-PROPOSED SCHEMATIC DISTRIBUTION OF CSS

SIZE DRAWING NUMBER:
A0 DELD-LSCL-100 -TP- RSN-3015


SULTANT:

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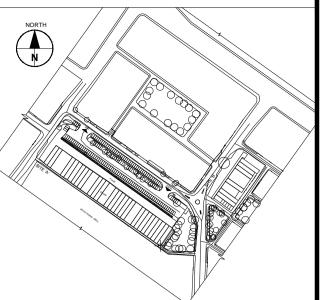
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DATE: 21/02/201



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CSS NO Distance KM

501 TO 56-502 0.1856

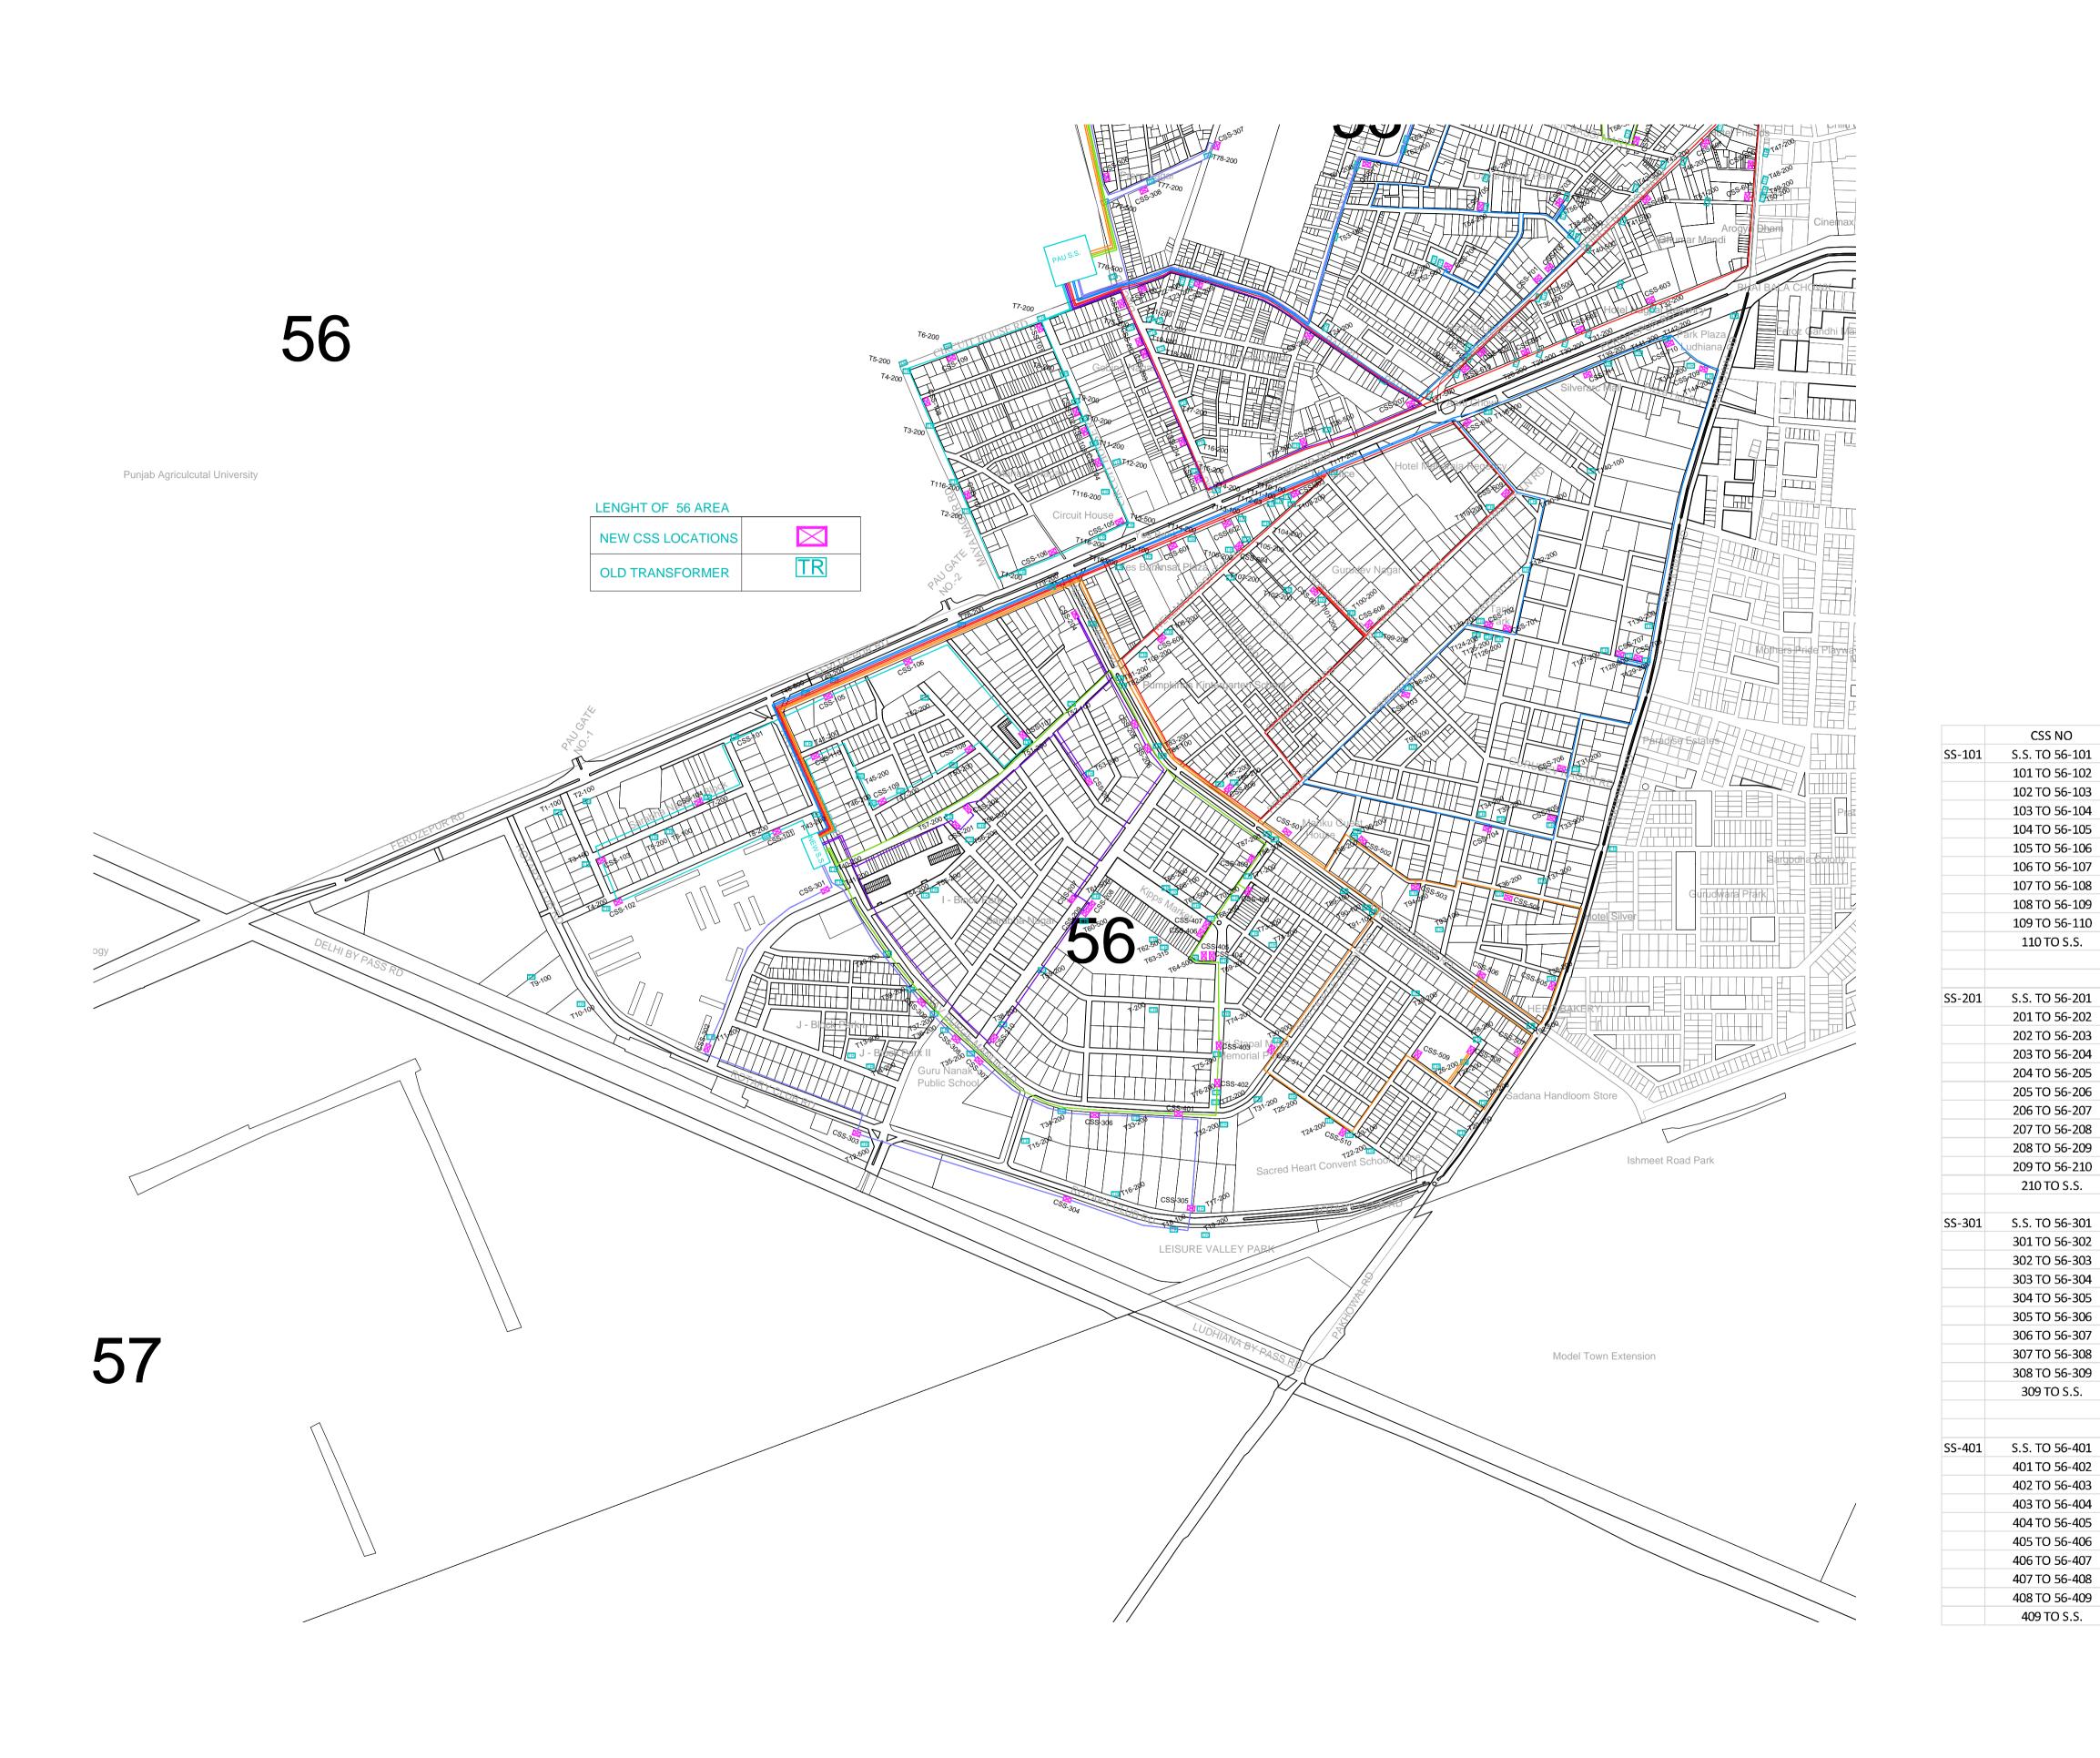502 TO 56-503 0.1190

503 TO 56-504 0.1730

504 TO 56-505 0.2624

505 TO 56-506 0.1967

506 TO 56-507 0.1893

508 TO 56-509 0.1325

509 TO 56-510 0.1834

510 TO 56-511 0.2054

601 TO 56-602 0.1026

602 TO 56-603 0.1294

603 TO 56-604 0.2483

604 TO 56-605 0.2123

605 TO 56-606 0.3571

606 TO 56-607 0.6109

607 TO 56-608 0.1404

608 TO 56-609 0.3367

609 TO 56-610 0.1415

701 TO 56-702 0.0364

702 TO 56-703 0.1952

703 TO 56-704 0.5397

704 TO 56-705 0.1447

705 TO 56-706 0.0900

706 TO 56-707 0.3373

610 TO S.S

0.0449 SS-701 S.S. TO 56-701 1.9088

1.8217

1.4624

511 TO S.S.

0.2710 SS-601 S.S. TO 56-601 0.9488

SS-501 S.S. TO 56-501 1.3426

CSS NO

110 TO S.S.

Distance KM

0.0679

0.2735

0.0659

0.1998

0.3240

0.1312

0.2521

0.1547

0.1723

0.1670

0.0444

0.2831

0.3263

0.1926

0.0327

0.2933

0.0298

0.0192

0.2512

0.4587

0.3265

0.3122

0.3508

0.2333

0.3063

0.2042

0.0395

0.0708

0.2741

0.7752

0.1028

0.0491

0.1465 0.0185

0.0738

0.0187

0.1012 0.0516

1.0156

409 TO S.S.

THIS DRAWING IS FOR INFORMATION ONLY.

07 TO 56-708	0.0361		
TO 56-709	0.5502		
09 TO 56-710	0.0910		
710 TO 56-711	0.1507		
711 TO S.S.	1.6857		
		DESCRIPTION	DRWN CHKD
		Beeckii Herv	DRWIN OF IRE

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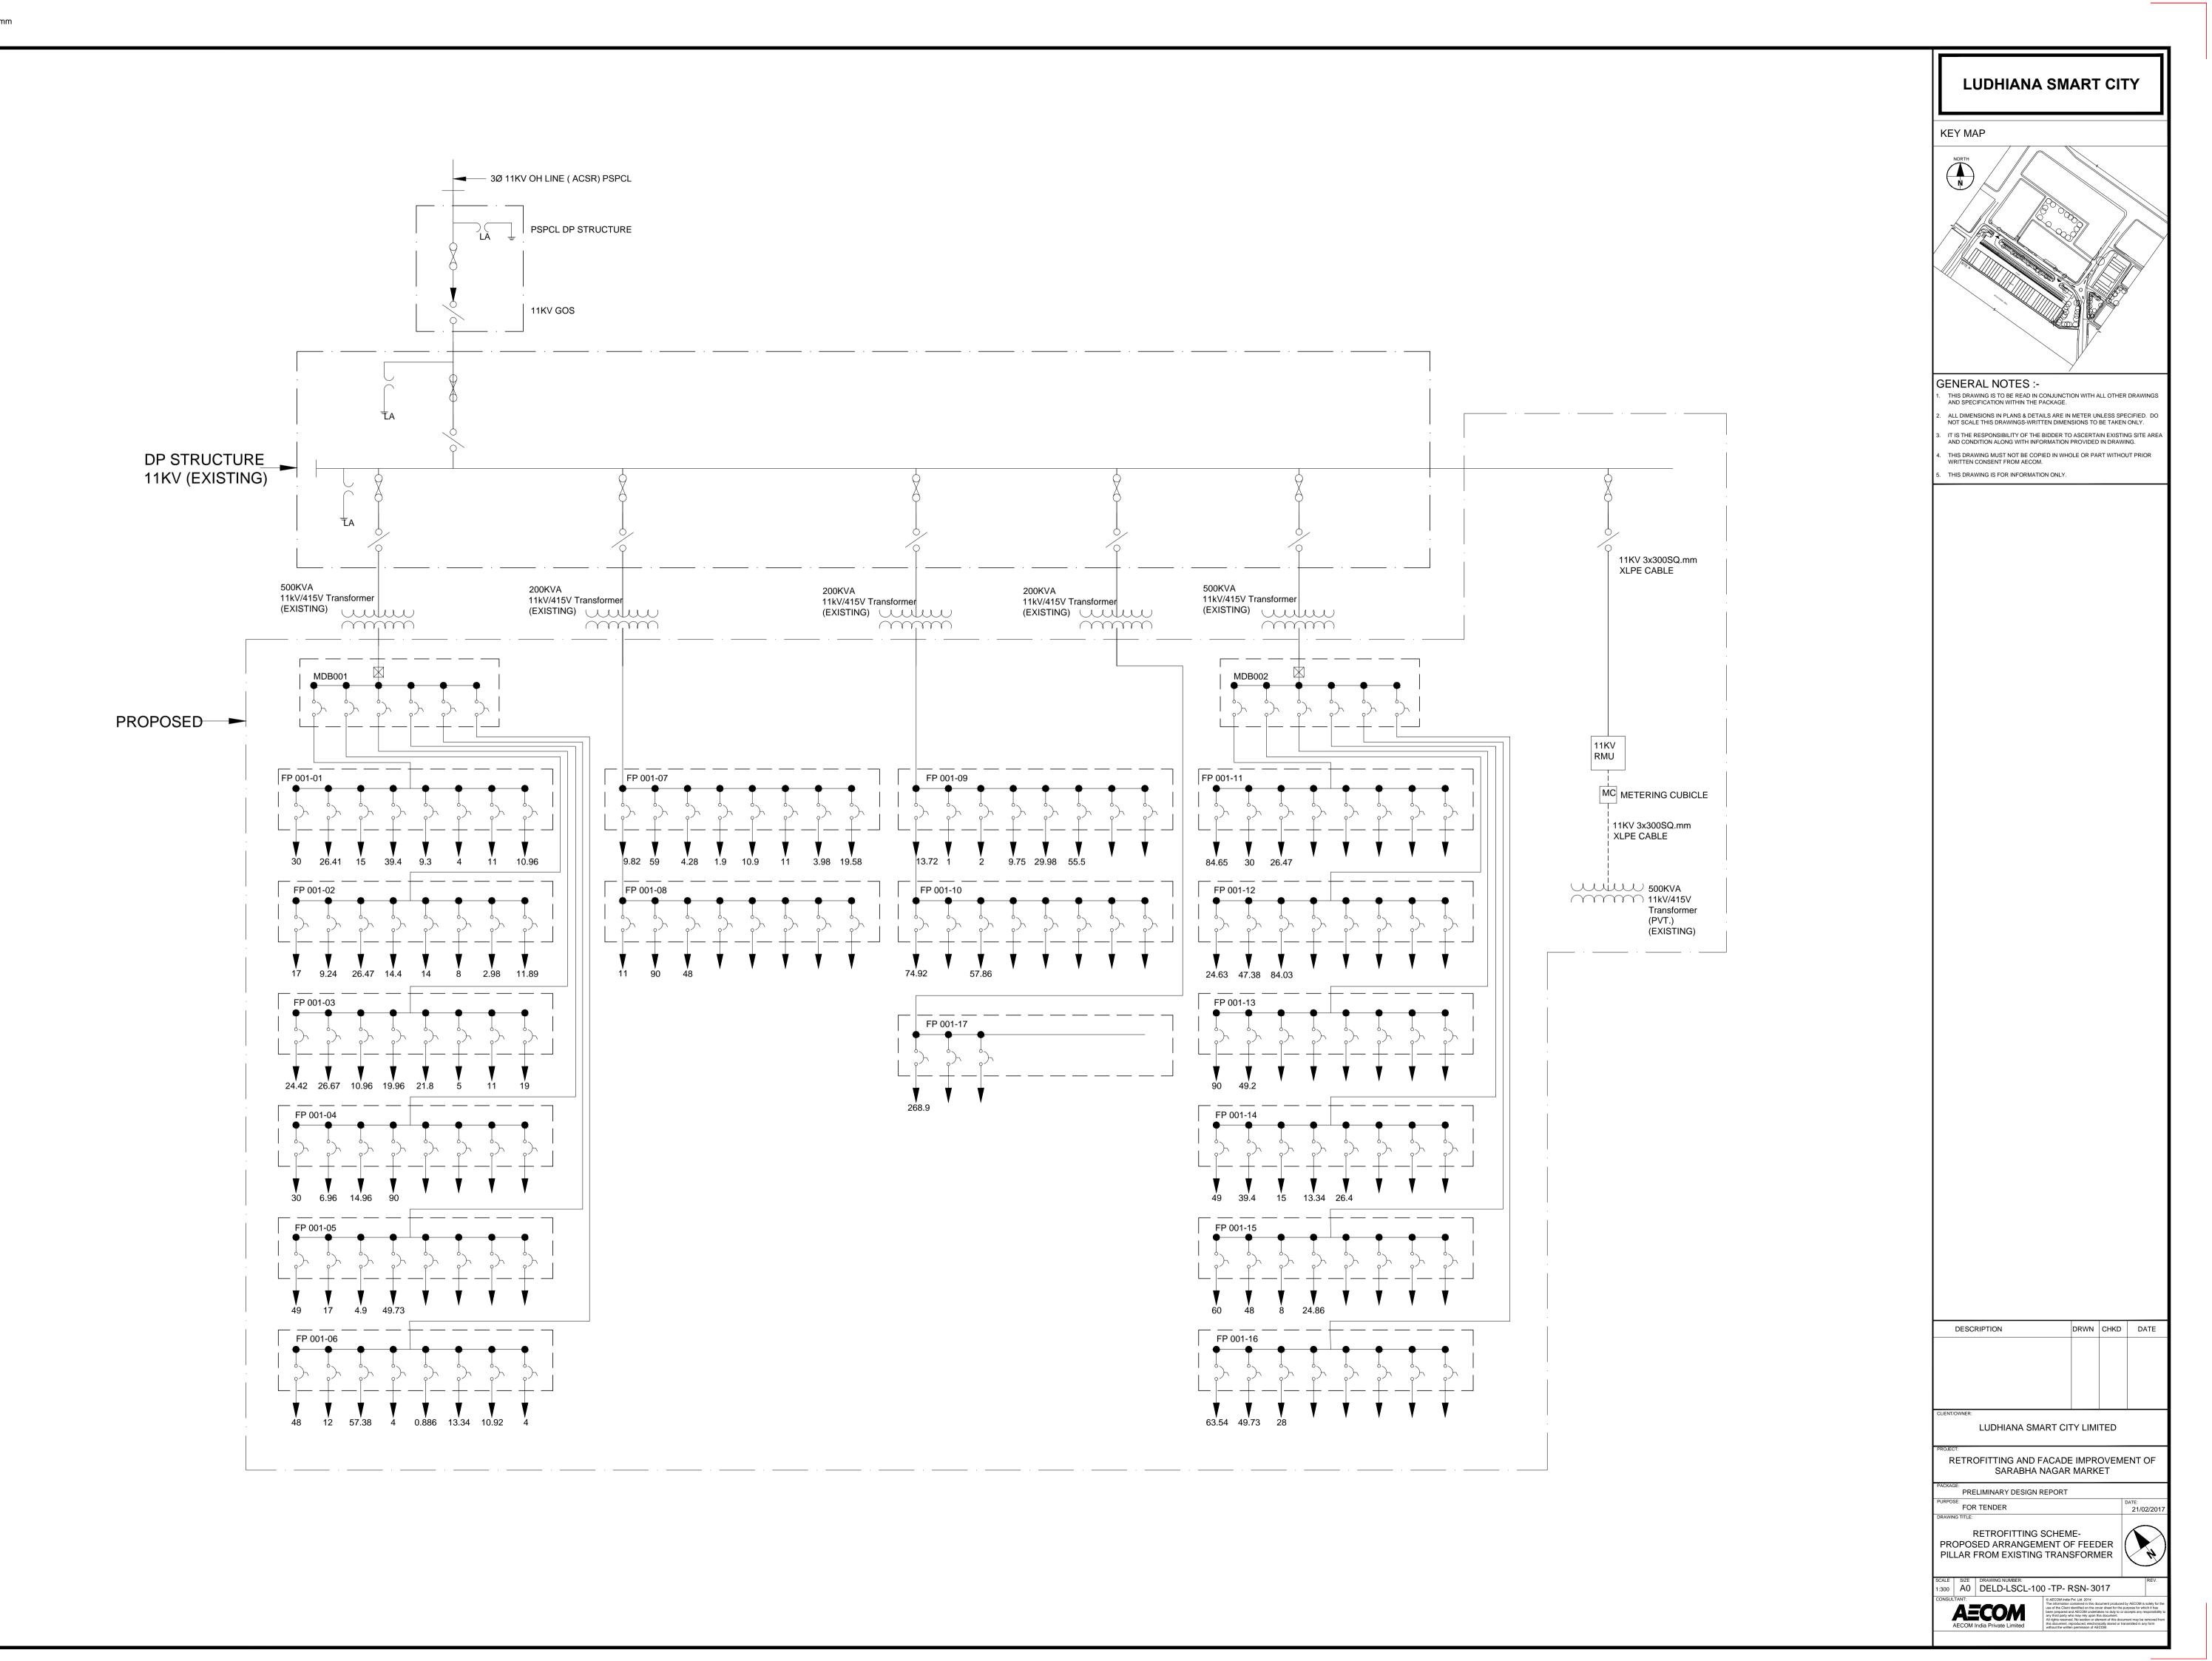
RETROFITTING AND FACADE IMPROVEMENT OF SARABHA NAGAR MARKET

PROPOSED NEW CSS

PRELIMINARY DESIGN REPORT FOR TENDER


RETROFITTING SCHEME-


LOCATIONS FOR ABD AREA 56 300 A0 DELD-LSCL-100 -TP- RSN-3016



INCOMER

200A

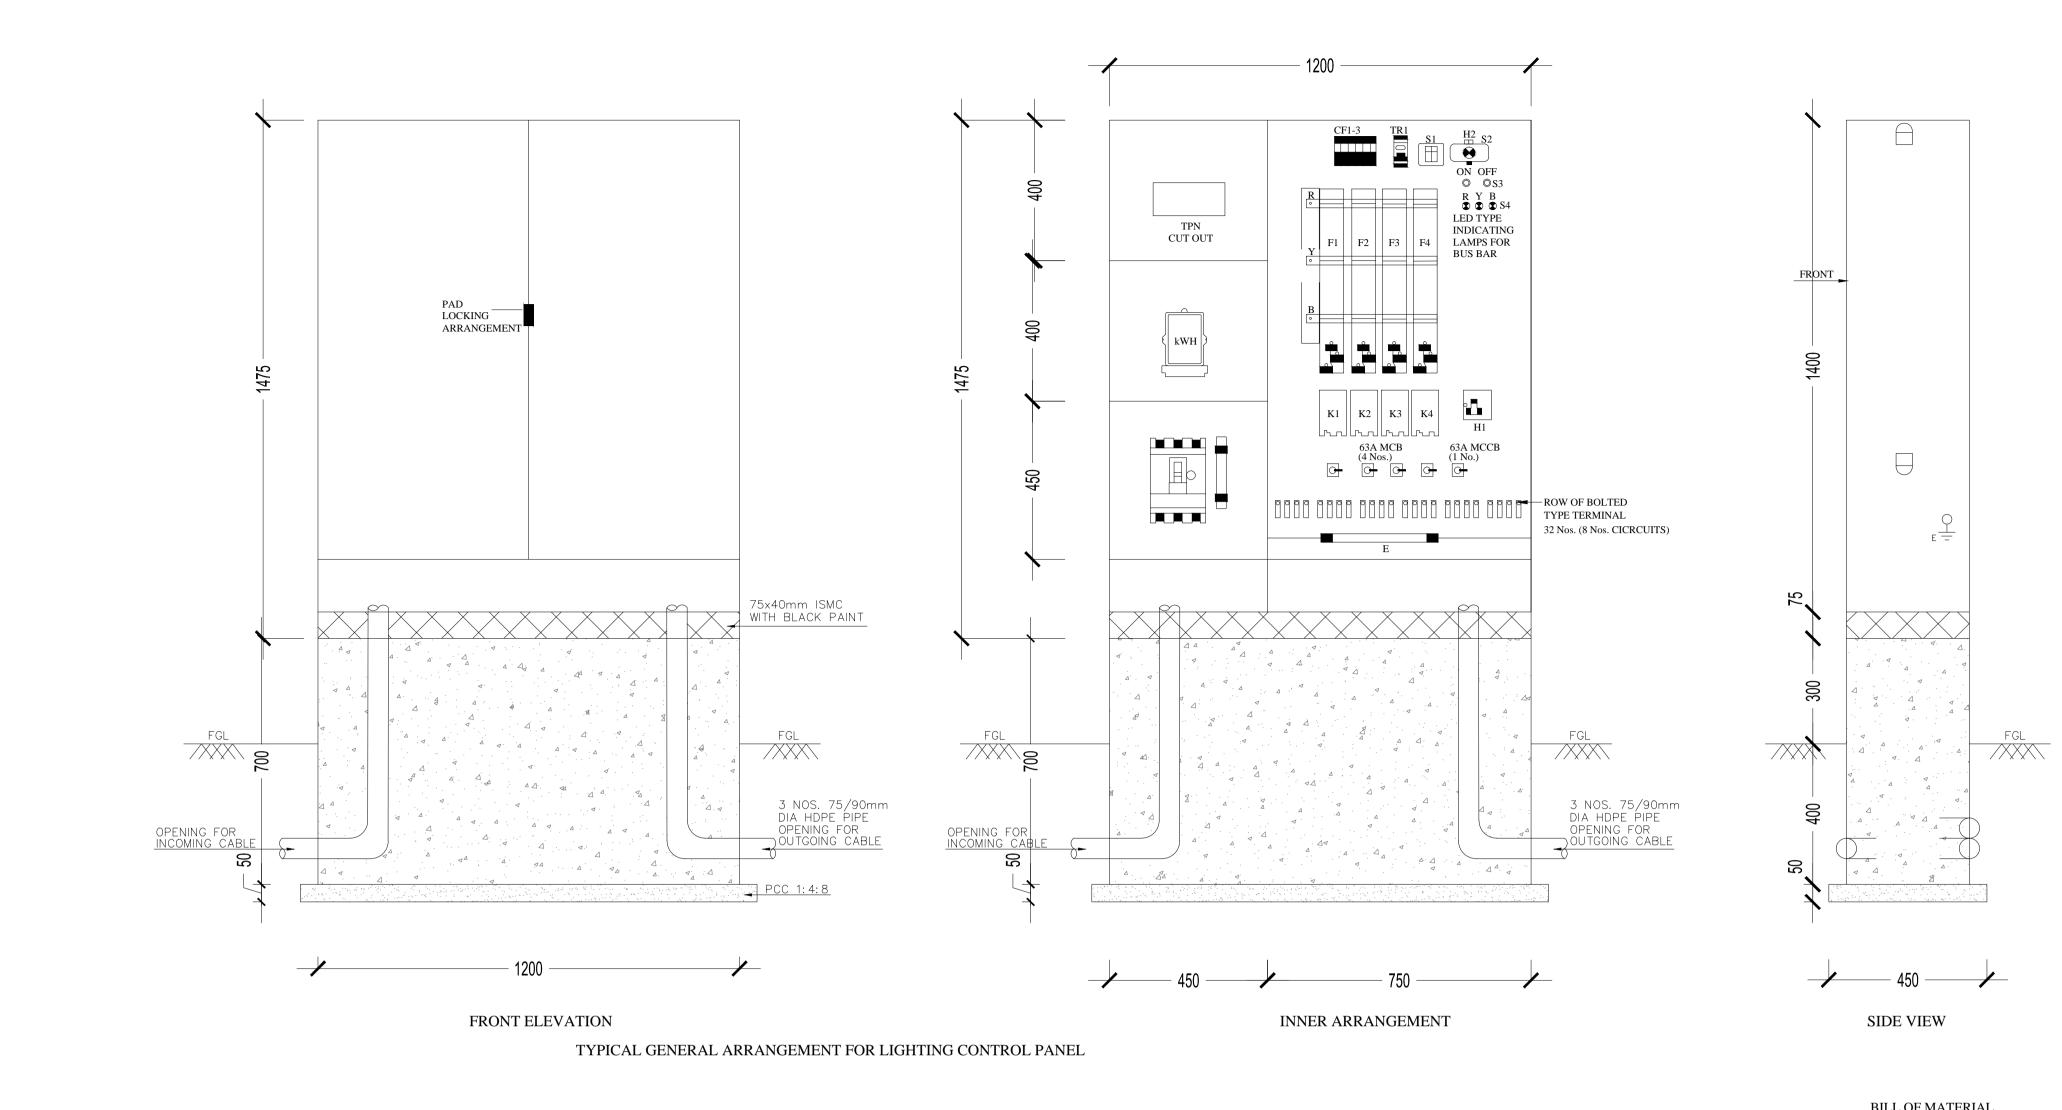

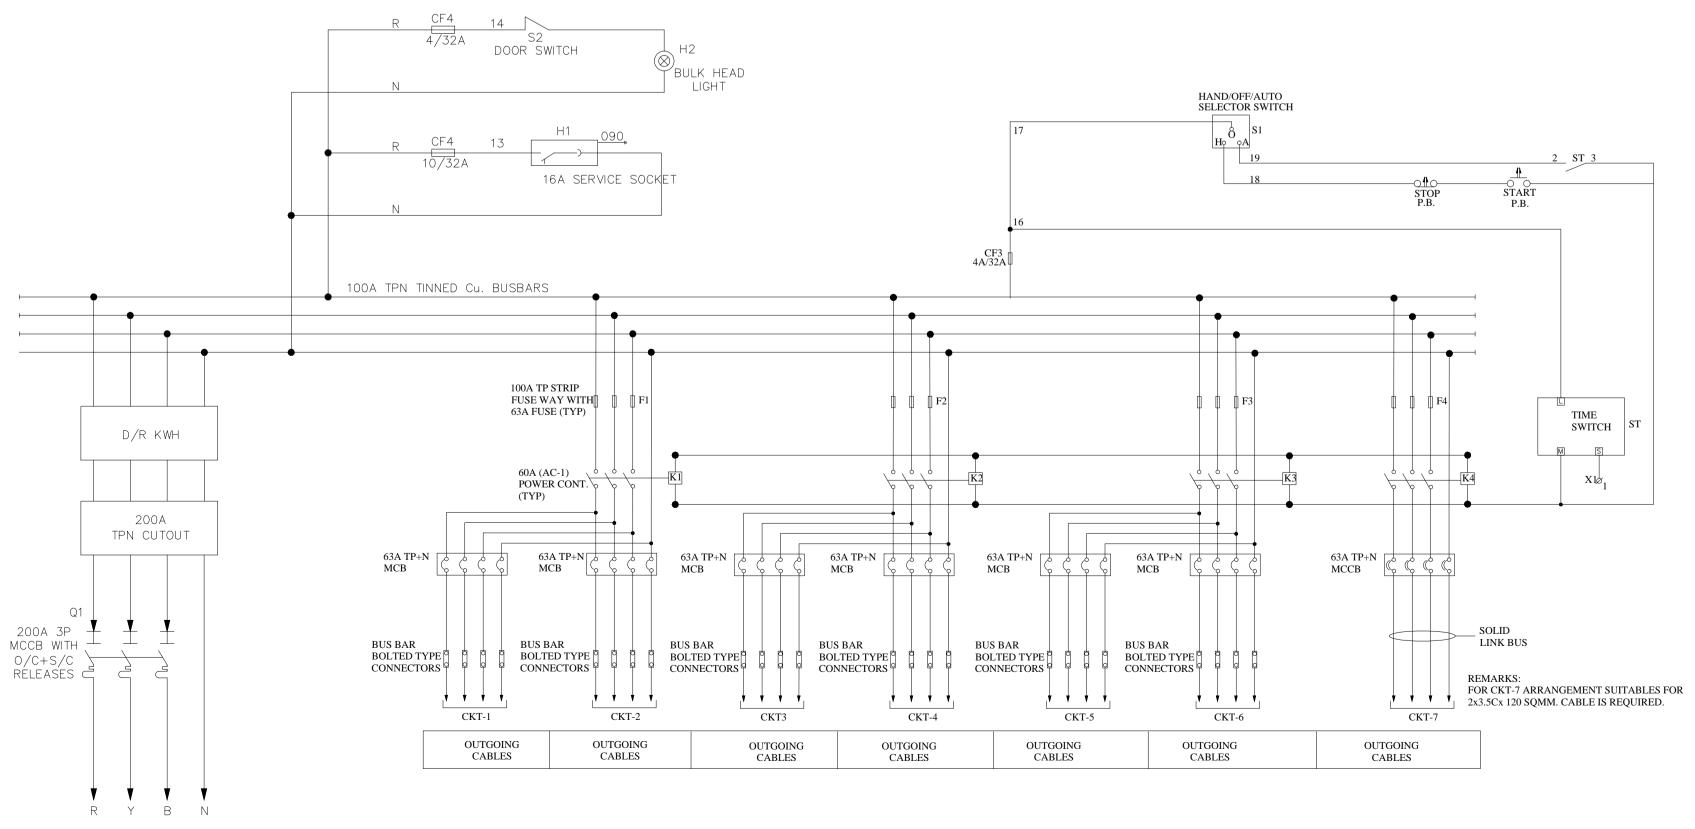

	BILL O	<u>F MATERIAL</u>		
REF.	DESCRIPTION	MAKE	TYPE	QTY.
-	IP 55, MS SHEET POWDER COATED ENCLOSURE	-	H-1200xW-1000 D-350MM	1 SET
Q1	200A TP MCCB WITH O/L & S/C PROT. RELEASES	MERLIN GERIN / L&T	31630 OR EQUIVALENT	1 SET
F1-F4	100A TP STRIP FUSE WAY WITH SIZE-00 'DIN' TYPE 63A HRC FUSES	PRONUTEC / ASIATIC	BTVA-PC-NH00-160A	4 SET
K1-K4	60A 3P (AC-1) CONTACTOR WITH 240V AC COIL	TELEMECANIQUE	LC1-D40UT	4 SET
CUTOUT	415V, 200A, SERVICE CUTOUT	REPUTED	TPN	1 SET
kWH	0-5A, kWH METER WITH A SET OF CT'S	SECURE / CONSERVE	AL — ASR	1 SET
TR1	24H & 7 DAYS, 1 CHANNEL DIGITAL TIME SWITCH	THEBEN/ASTRO	TS610	1 SET
S1	3 POSITION SELECTOR SWITCH, AUTO/OFF/MANUAL	TELEMECANIQUE	XB5AD33	1 SET
S2	DOOR SWITCH (SNAP ACTION WITH PUSH ROD)	KAYCEE	KLS 000X-0B	1 SET
S3	PUSH BUTTON	TELEMECANIQUE	PUSH BUTTON TYPE	2 SET
S4	LED INDICATING LAMP	TELEMECANIQUE	LED TYPE	2 SET
H1	240V AC, POWER SOCKET	LEGRAND	METAL CLAD	1 SET
H2	240V AC, 60W BULKHEAD LIGHT	REPUTED	E72	1 SET
CF1-4	32A, 1P ISOLATABLE FUSE CARRIER 4A, 10x38 DISTRIBUTION FUSE, TYPE gl-gg	MERLIN GERIN SOCOMEC	STI(15636) 6012 0004	2 SET 1 SET
Ç	63A 10KA MCB	MDS / HAGER	4 POLE	6 SET
C	63A 10KA MCCB	MDS / HAGER	4 POLE	1 SET
Ø	BOLTED TYPE BUS BAR TERMINALS (63A)	ELMEX	LINK TYPE	24 SE ⁻

REMARKS:

LP - LIGHTING POLE

1. SLD OF THE CONTROL SYSTEM ON LAMINATED SHEET

TO BE KEPT IN FEEDER PILLAR.

- 1. ALL DIMESNSIONS ARE IN mm. 2. MAIN SUPPLY: 415V, 3Ø, 50Hz, AC
- 3. CONTROL SUPPLY: 240V, 1Ø, 2W, 50Hz, AC
- 4. INSTALLATION: OUTDOOR PLINTH MOUNTED.
- 5. DEGREE OF PROTECTION: IP-55


NOTES:

- 6. COLOUR: RAL 7032/GREEN TO BE APPROVED BY CLIENT. 7. MAIN BUSBAR : RATED CURRENT 100A
 - : 25kA/1 SEC. S/C CURRENT
 - : 1x40x5 TINNED CU. PH. : 1x40x5 TINNED CU. - N.

: OUTGOING - BOTTOM

- : 1x40x5 TINNED CU. E. 8. CONTROL WIRING : PVC Cu. LINKS
- : VOLTAGE CKT. 1.5 SQMM. 9. POWER CONNECTION : SOLID Cu. LINKS 10. CABLE ENTRY: INCOMING - BOTTOM
- 11. EARTHING: 50x6mm GI FLAT. 12. BUSBAR SUPPORT : FRP / DMC

LUDHIANA SMART CITY

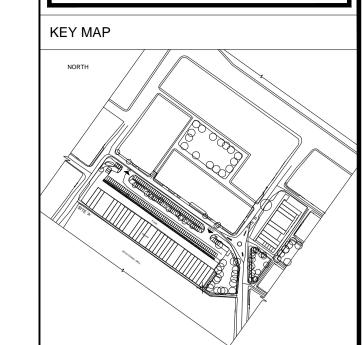

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DESCRIPTION DRWN CHKD DATE

LUDHIANA SMART CITY LIMITED

RETROFITTING AND FACADE IMPROVEMENT OF SARABHA NAGAR MARKET


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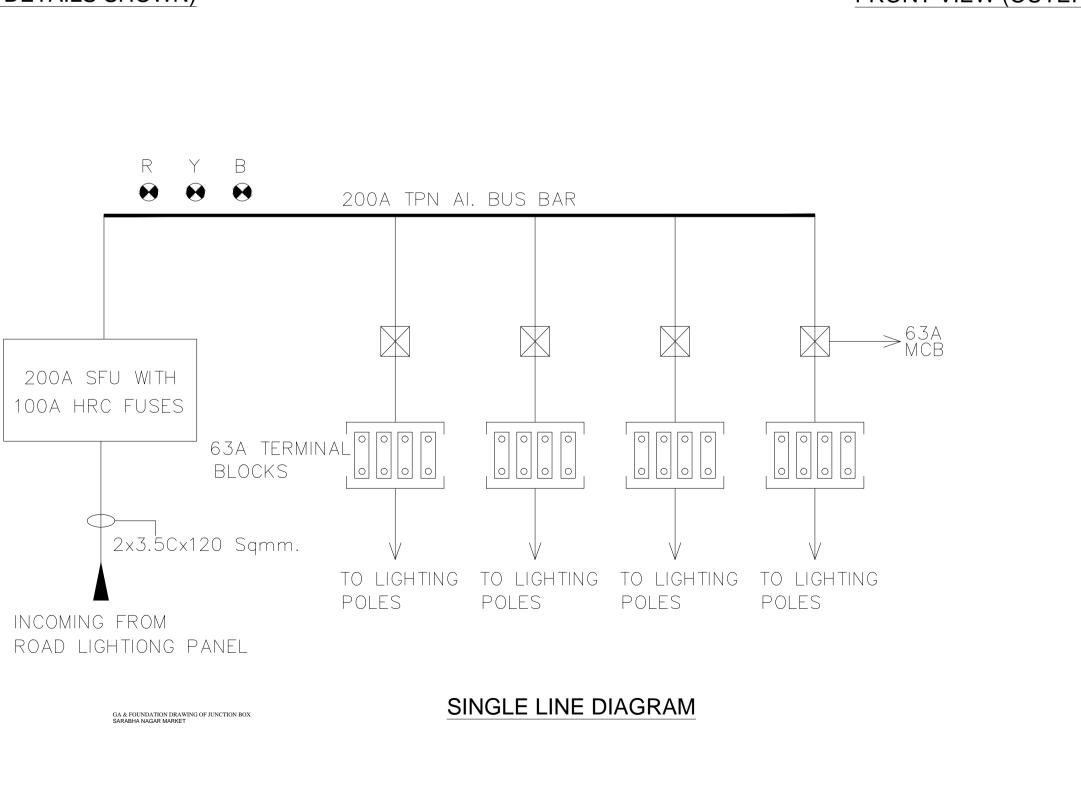
FOR TENDER RETROFITTING SCHEME-

PROPOSED GA AND SLD OF

LIGHTING CONTROL PANEL

A0 DELD-LSCL-100 -TP- RSN-3018



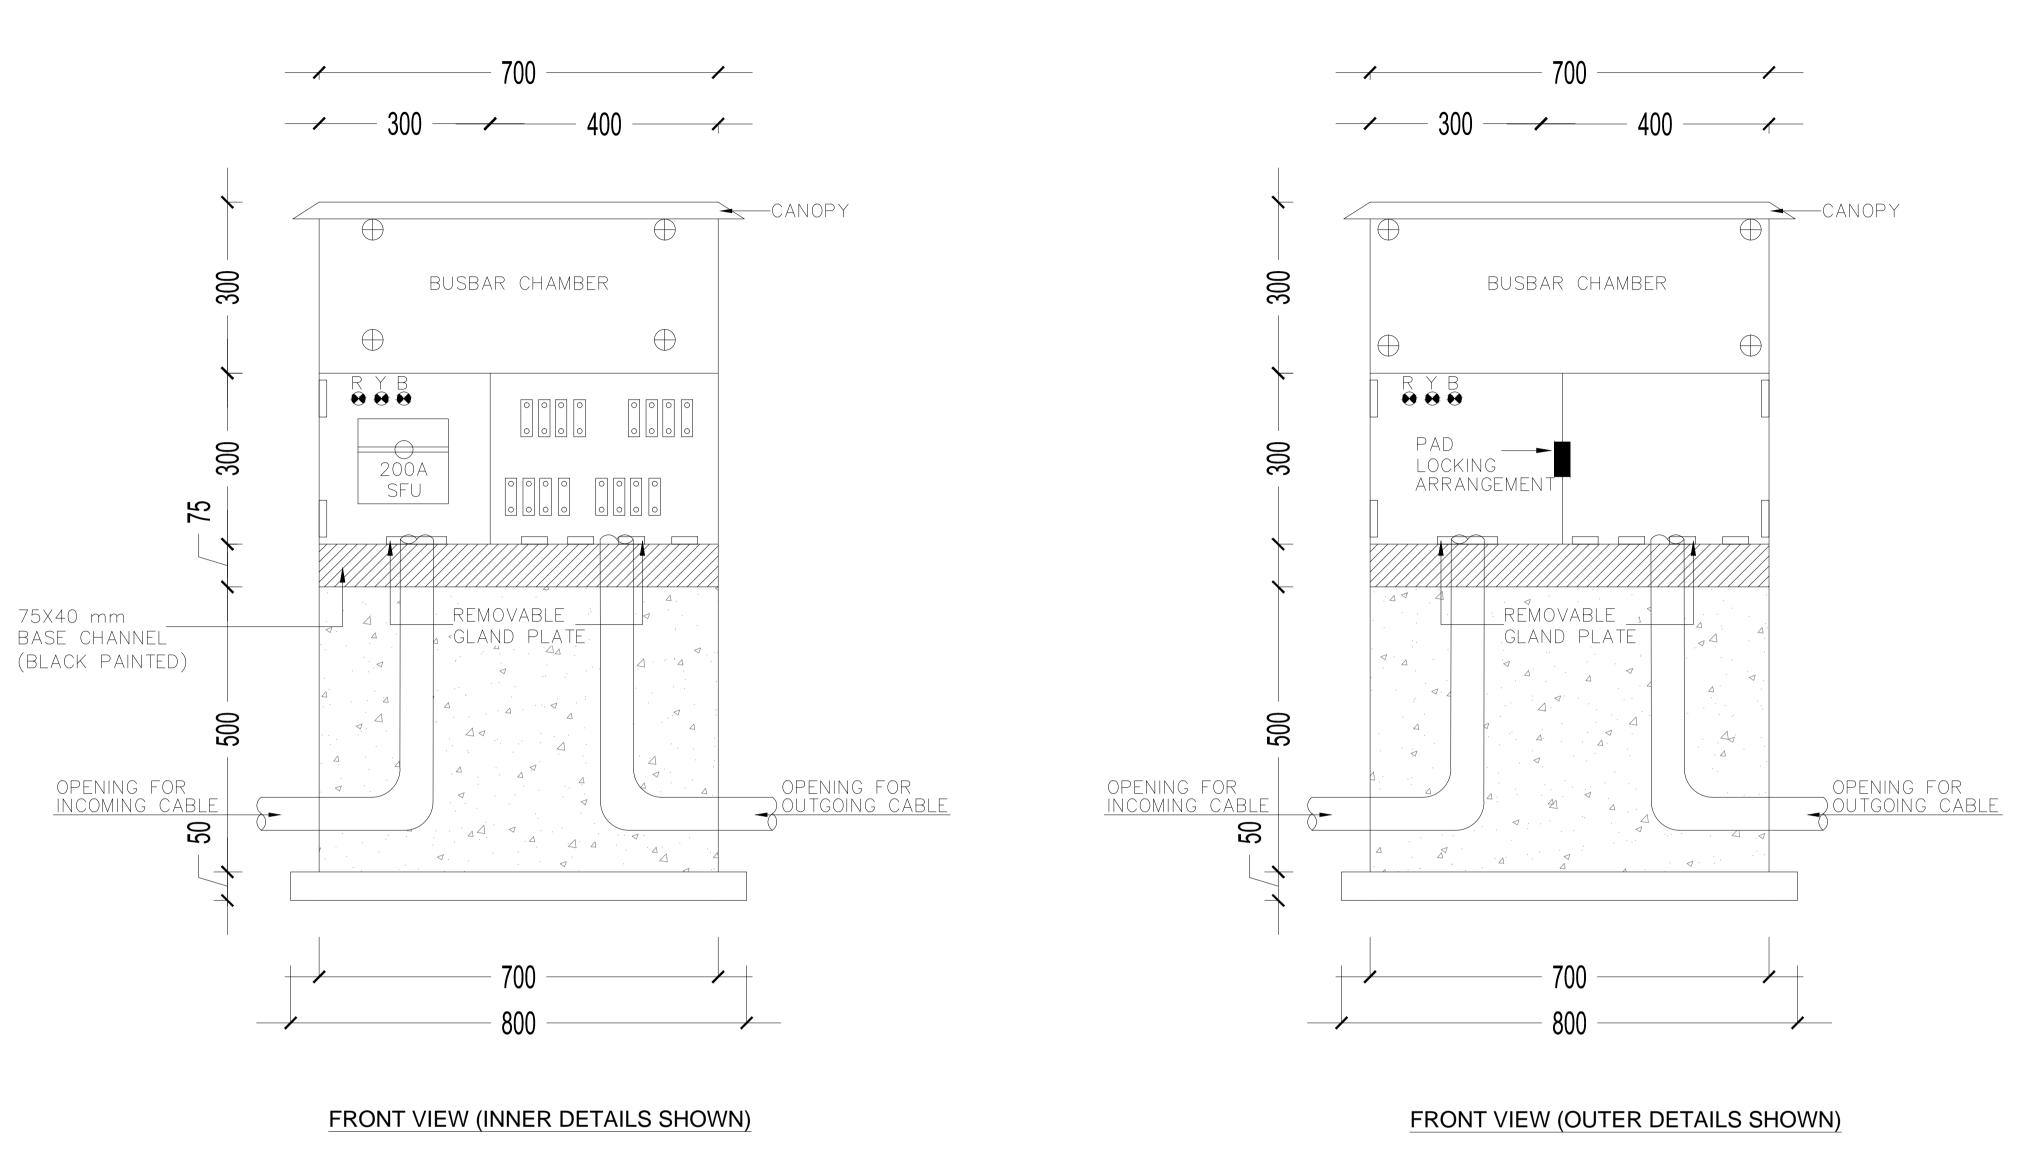

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DESCRIPTION

DRWN CHKD DATE

LUDHIANA SMART CITY LIMITED


RETROFITTING AND FACADE IMPROVEMENT OF SARABHA NAGAR MARKET

PRELIMINARY DESIGN REPORT

RETROFITTING SCHEME-PROPOSED GA AND FOUNDATION OF JUNCTION BOX

A0 DELD-LSCL-100 -TP- RSN-3019


FOR TENDER

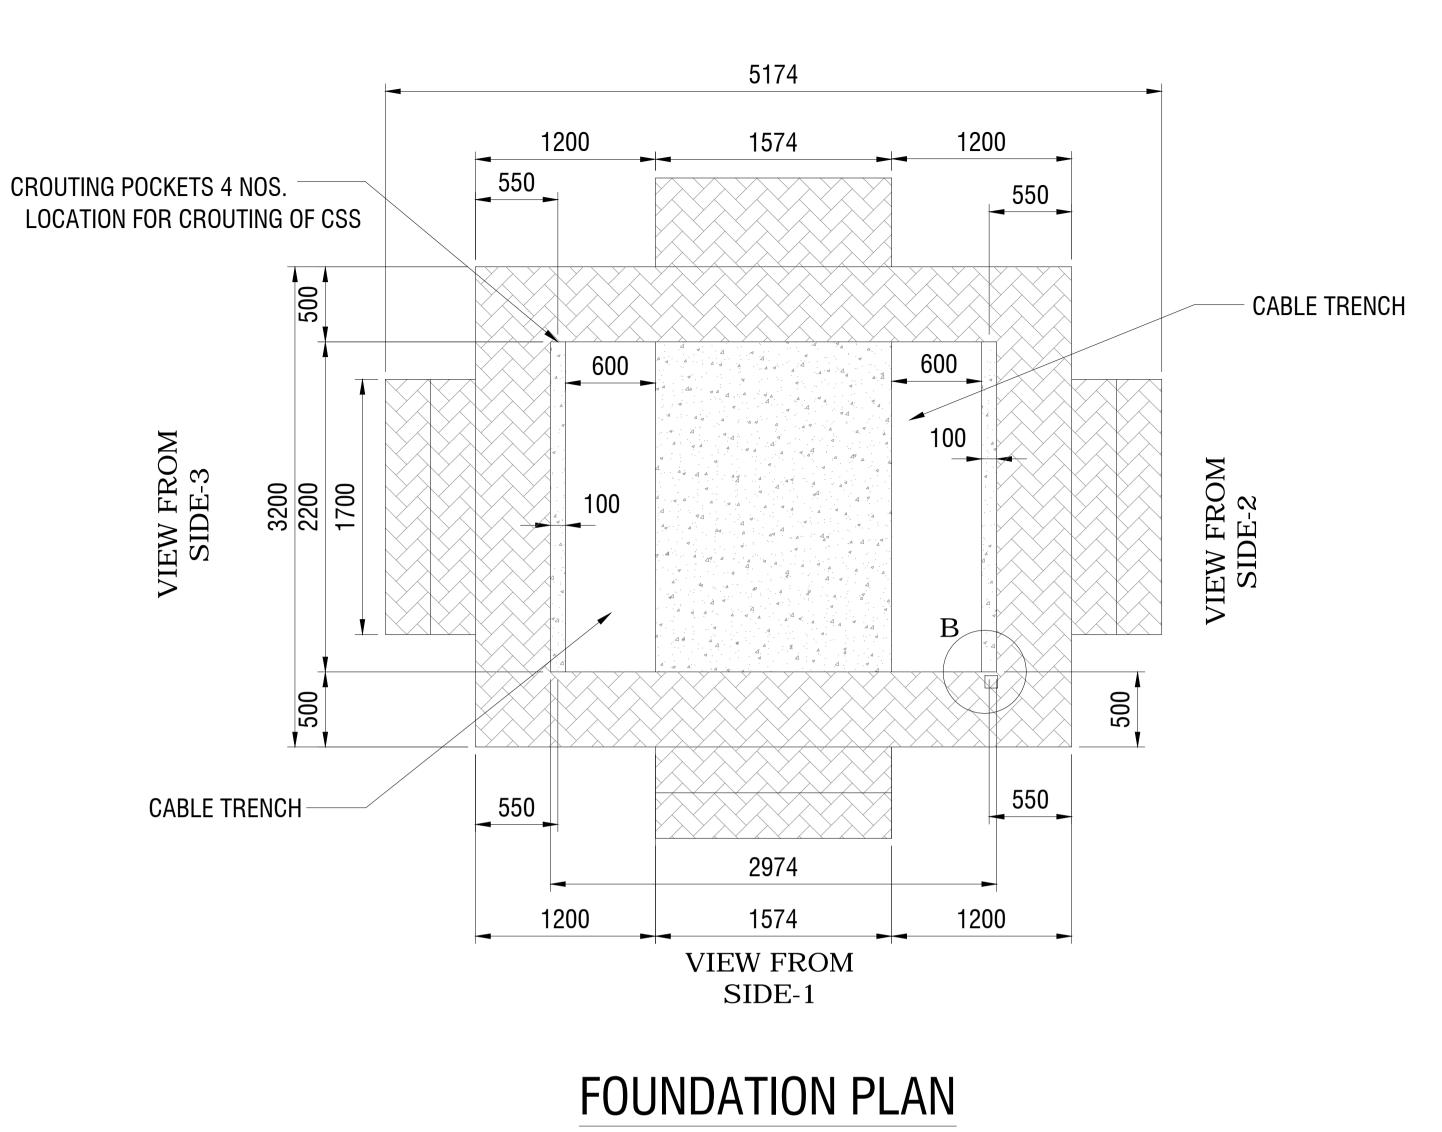

300,300 300,300 340 3800


VIEW FROM SIDE-3

SCALE 1:50

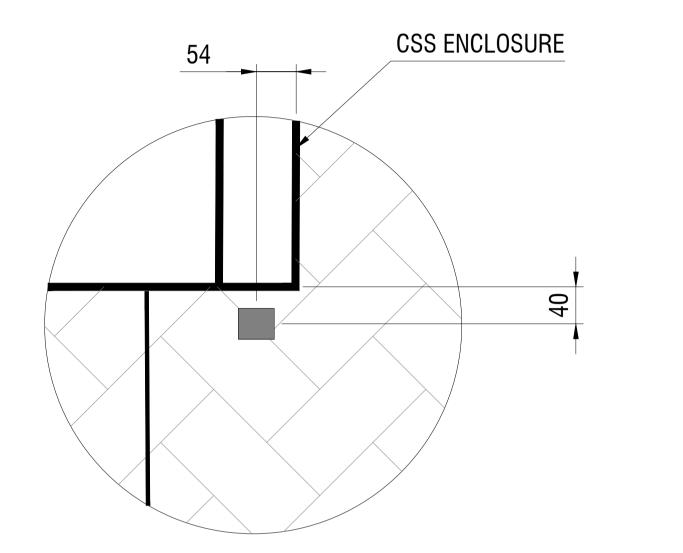


DETAIL OF VIEW-B **SCALE 1:50**


SCALE 1:50

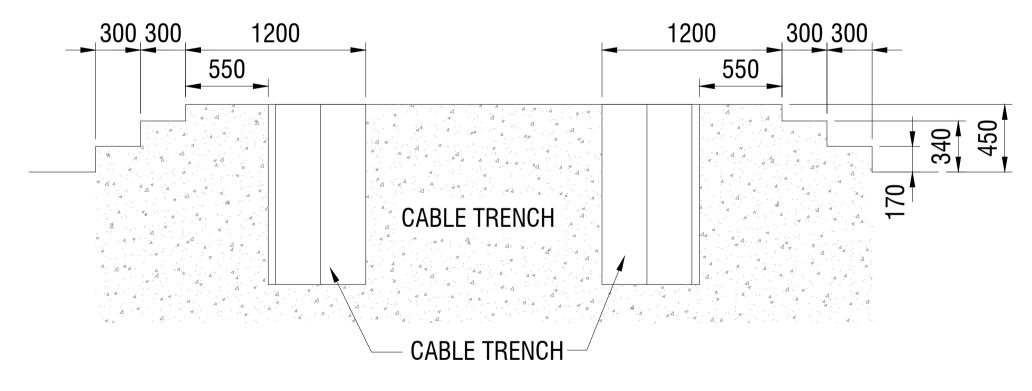


VIEW FROM SIDE-1 **SCALE 1:50**

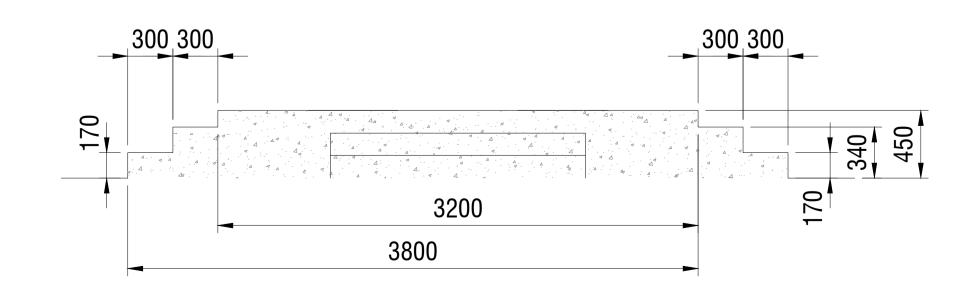


VIEW FROM SIDE-2 **SCALE 1:50**

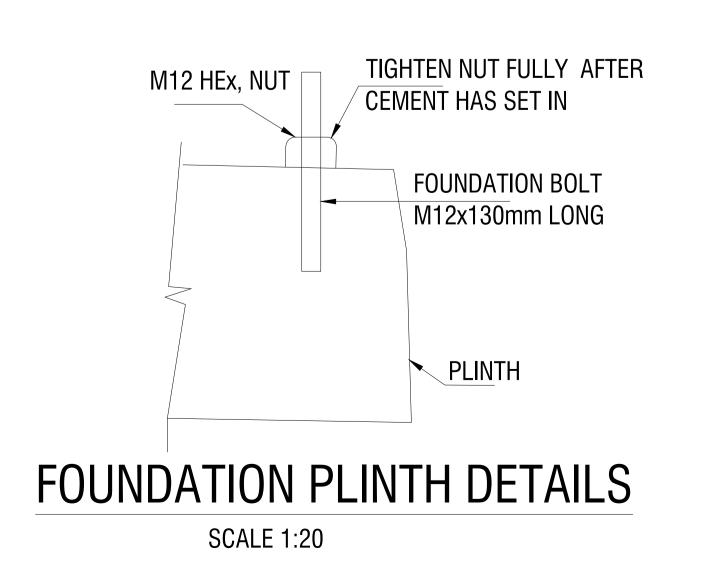

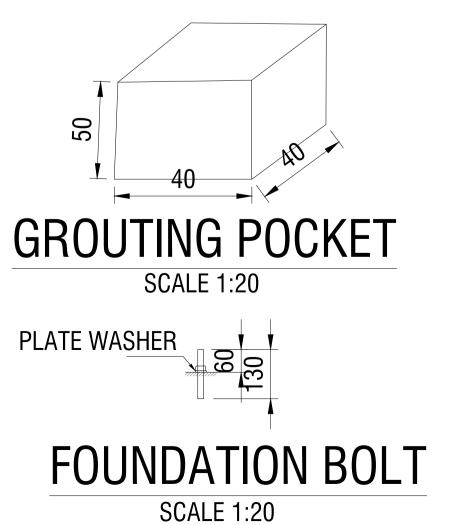

LUDHIANA SMART CITY

KEY MAP

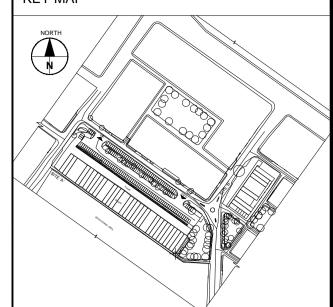

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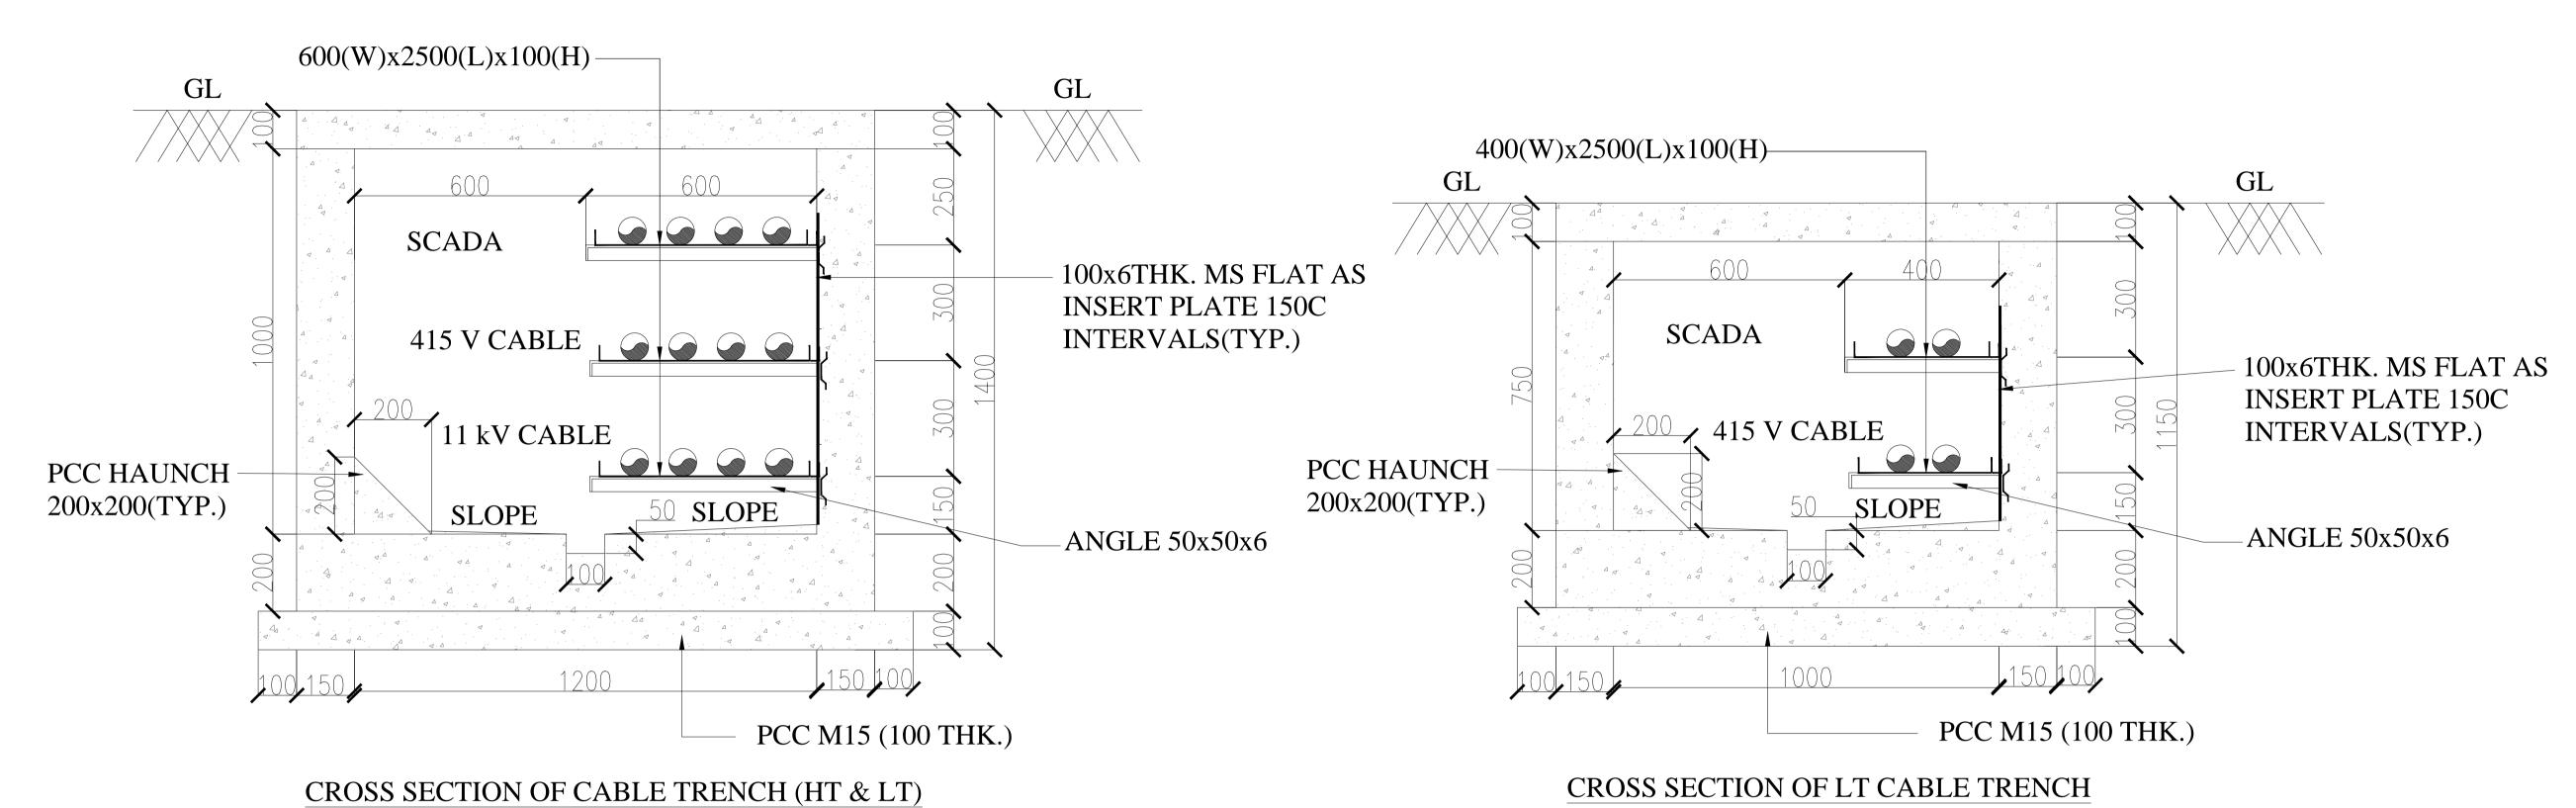
- 4. HT/LT CABLE SHOULD BE MIN 1.2 M
- 5. THE TOP OF THE PLINTH HAS TO BE LEVELED (WITH MAX VARIATION OF 4MM). THIS IS FESENTIAL FOR PROPER ALIGNMENT OF PACKAGE
- SUBSTATION DOORS.
- BOTTOM SIDE OF CSS.
- INTERVAL EARTHING WILL BE BROUGHT ON EARTHING POINTS INSIDE


DESCRIPTION DRWN CHKD DATE LUDHIANA SMART CITY LIMITED RETROFITTING AND FACADE IMPROVEMENT OF

FOR TENDER


RETROFITTING SCHEME-PROPOSED FOUNDATION DETAIL FOR CSS

A0 DELD-LSCL-100 -TP- RSN-3020 **AECOM**




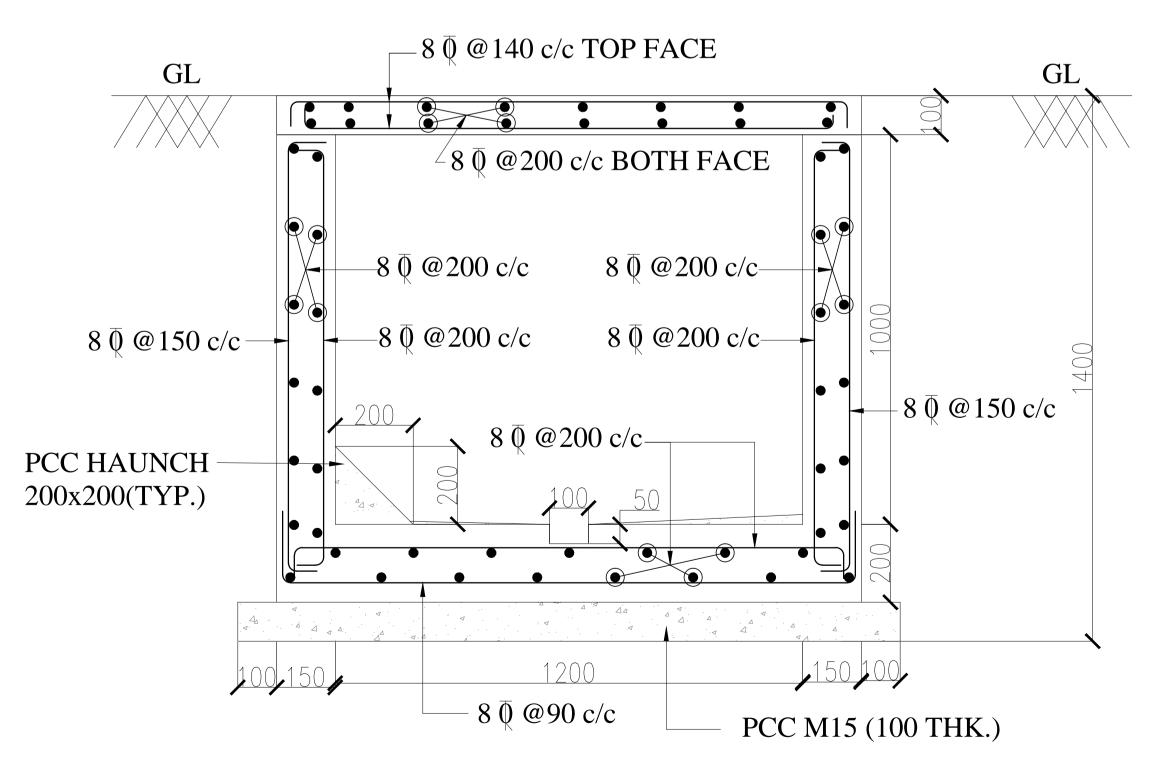



CROSS SECTION OF CABLE TRENCH (HT & LT)

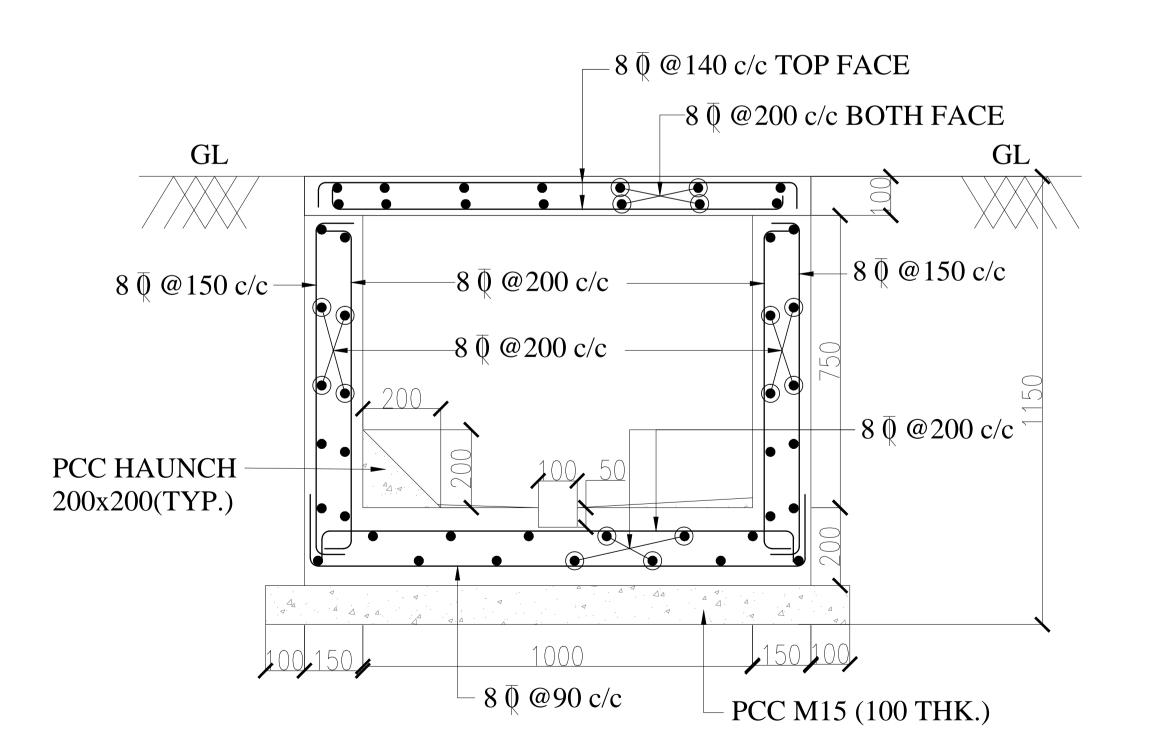


CROSS SECTION OF LT CABLE TRENCH

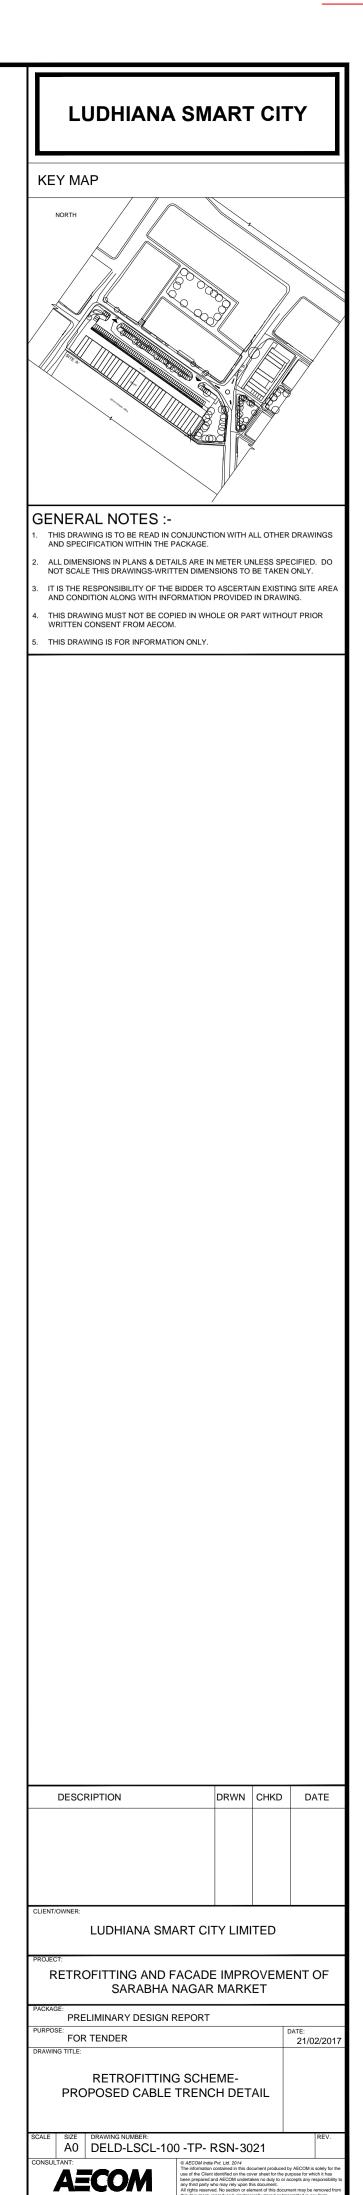

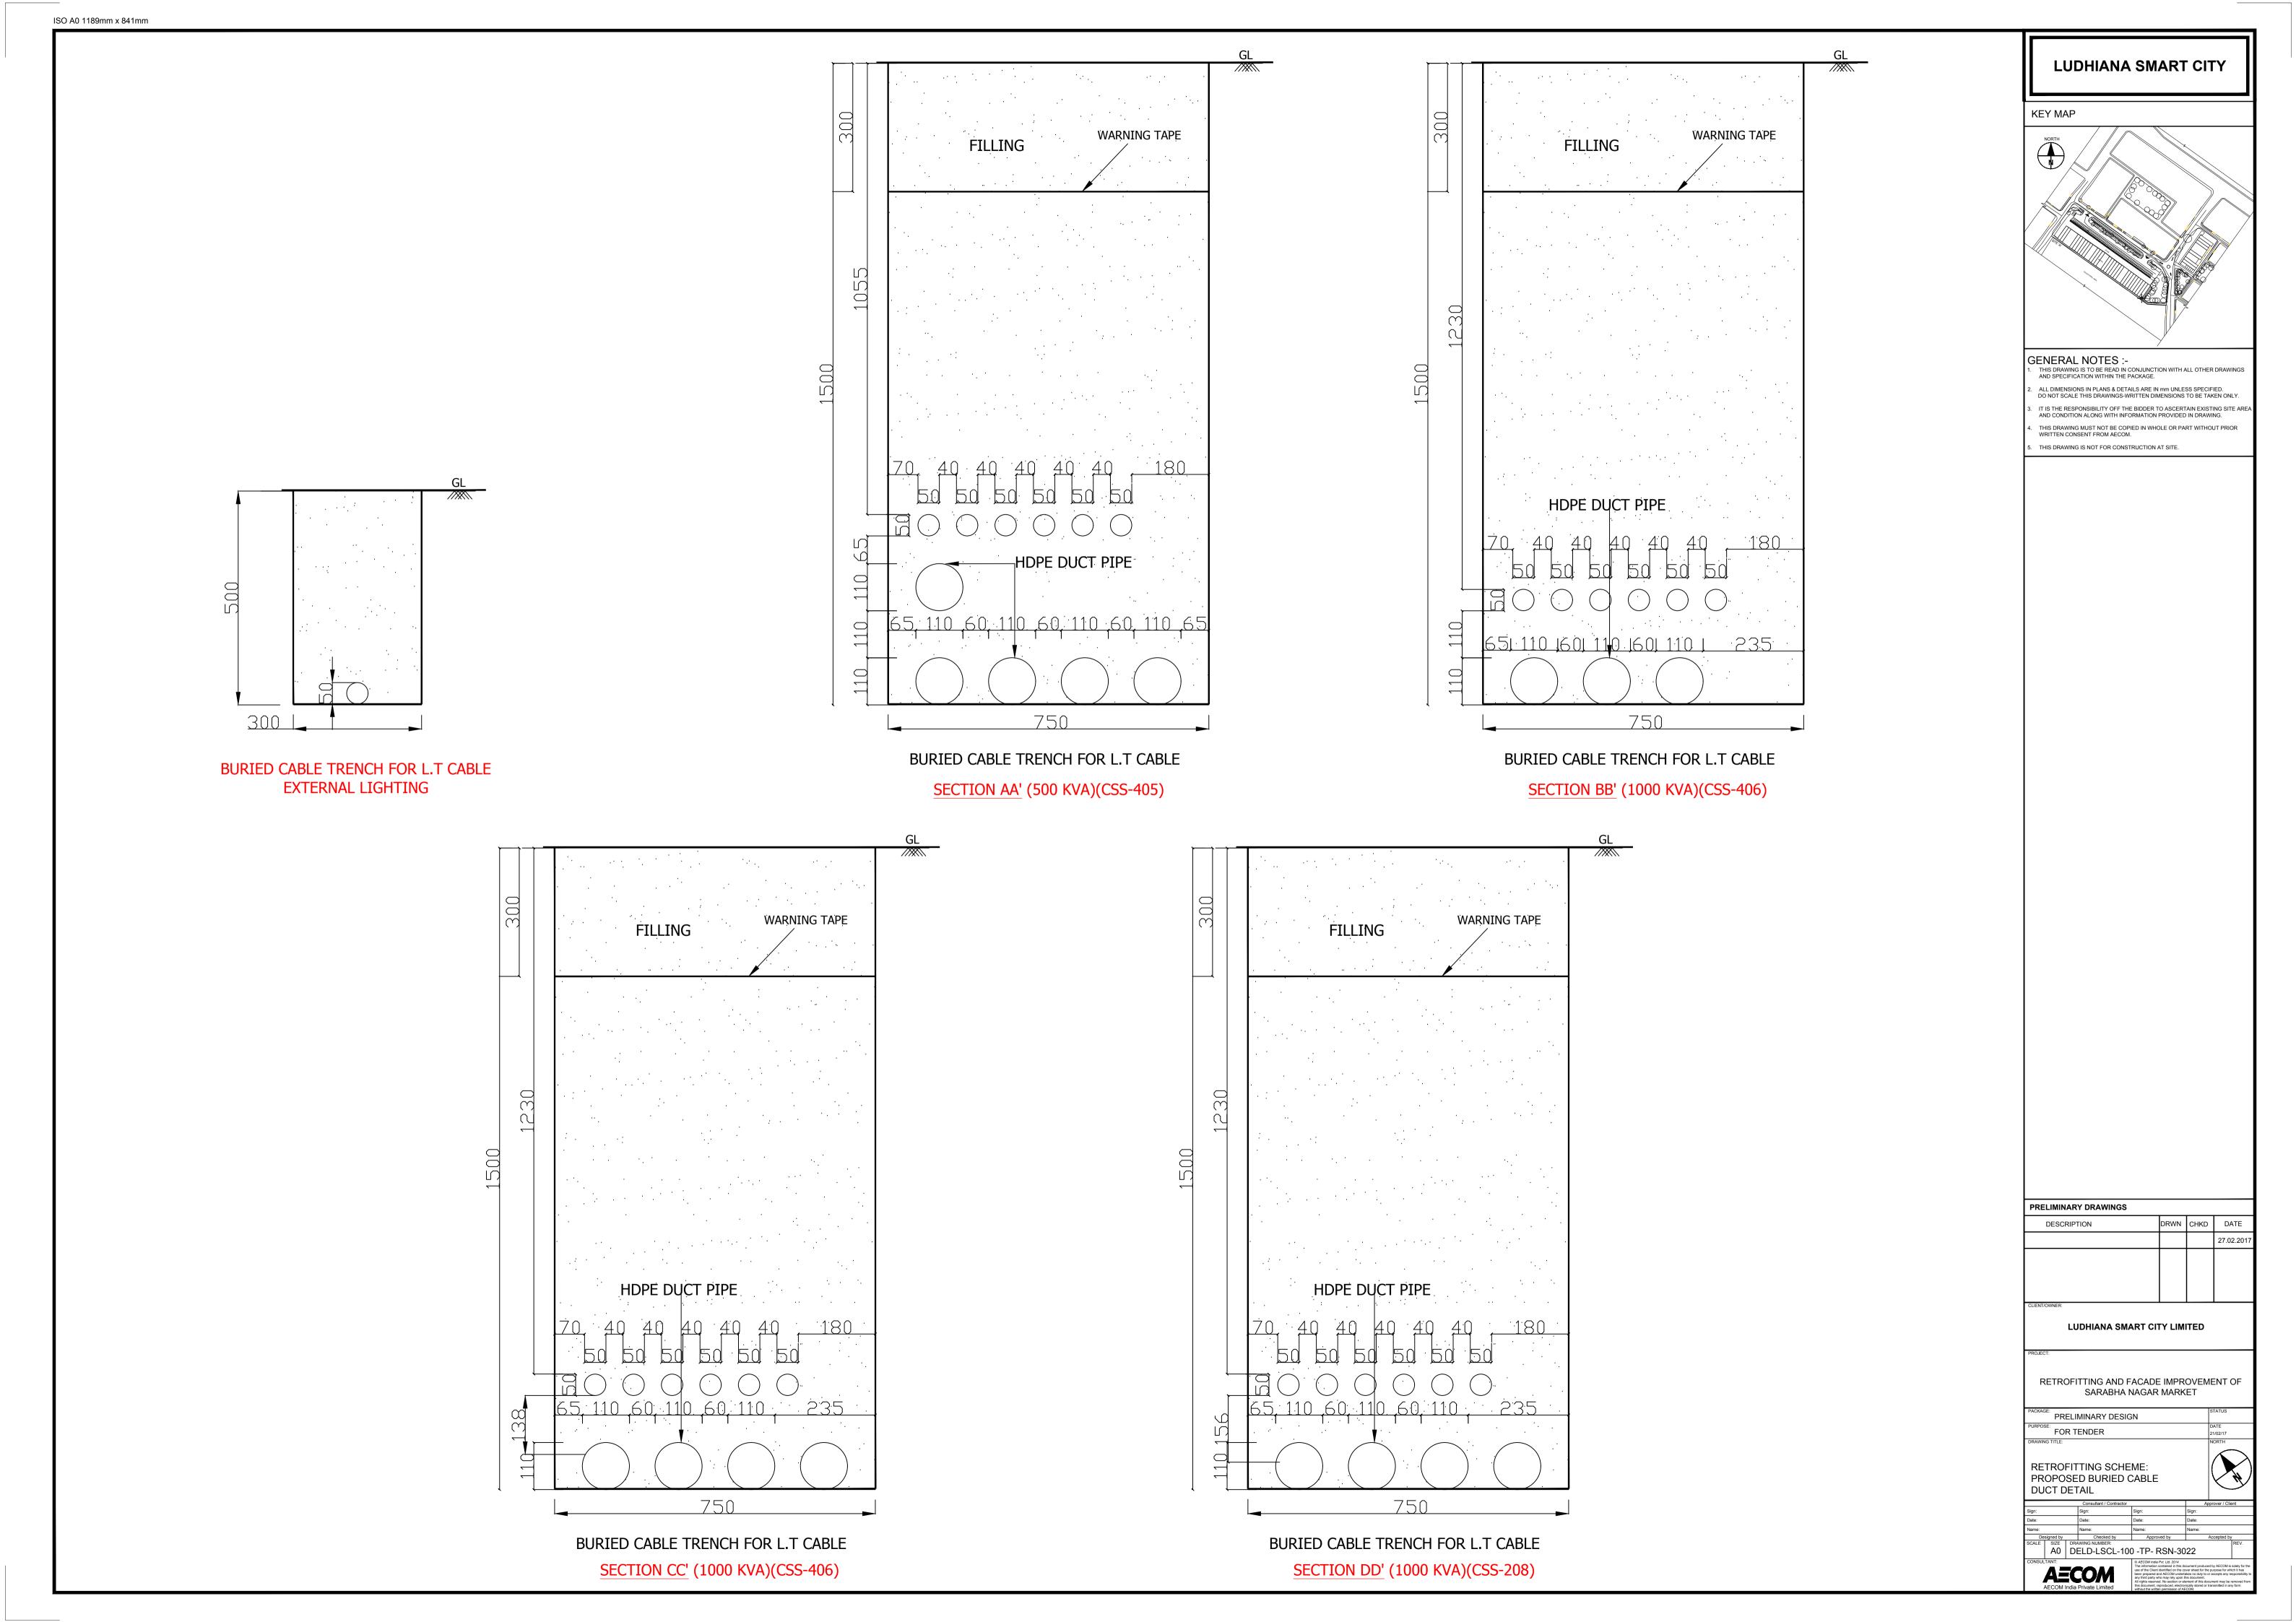

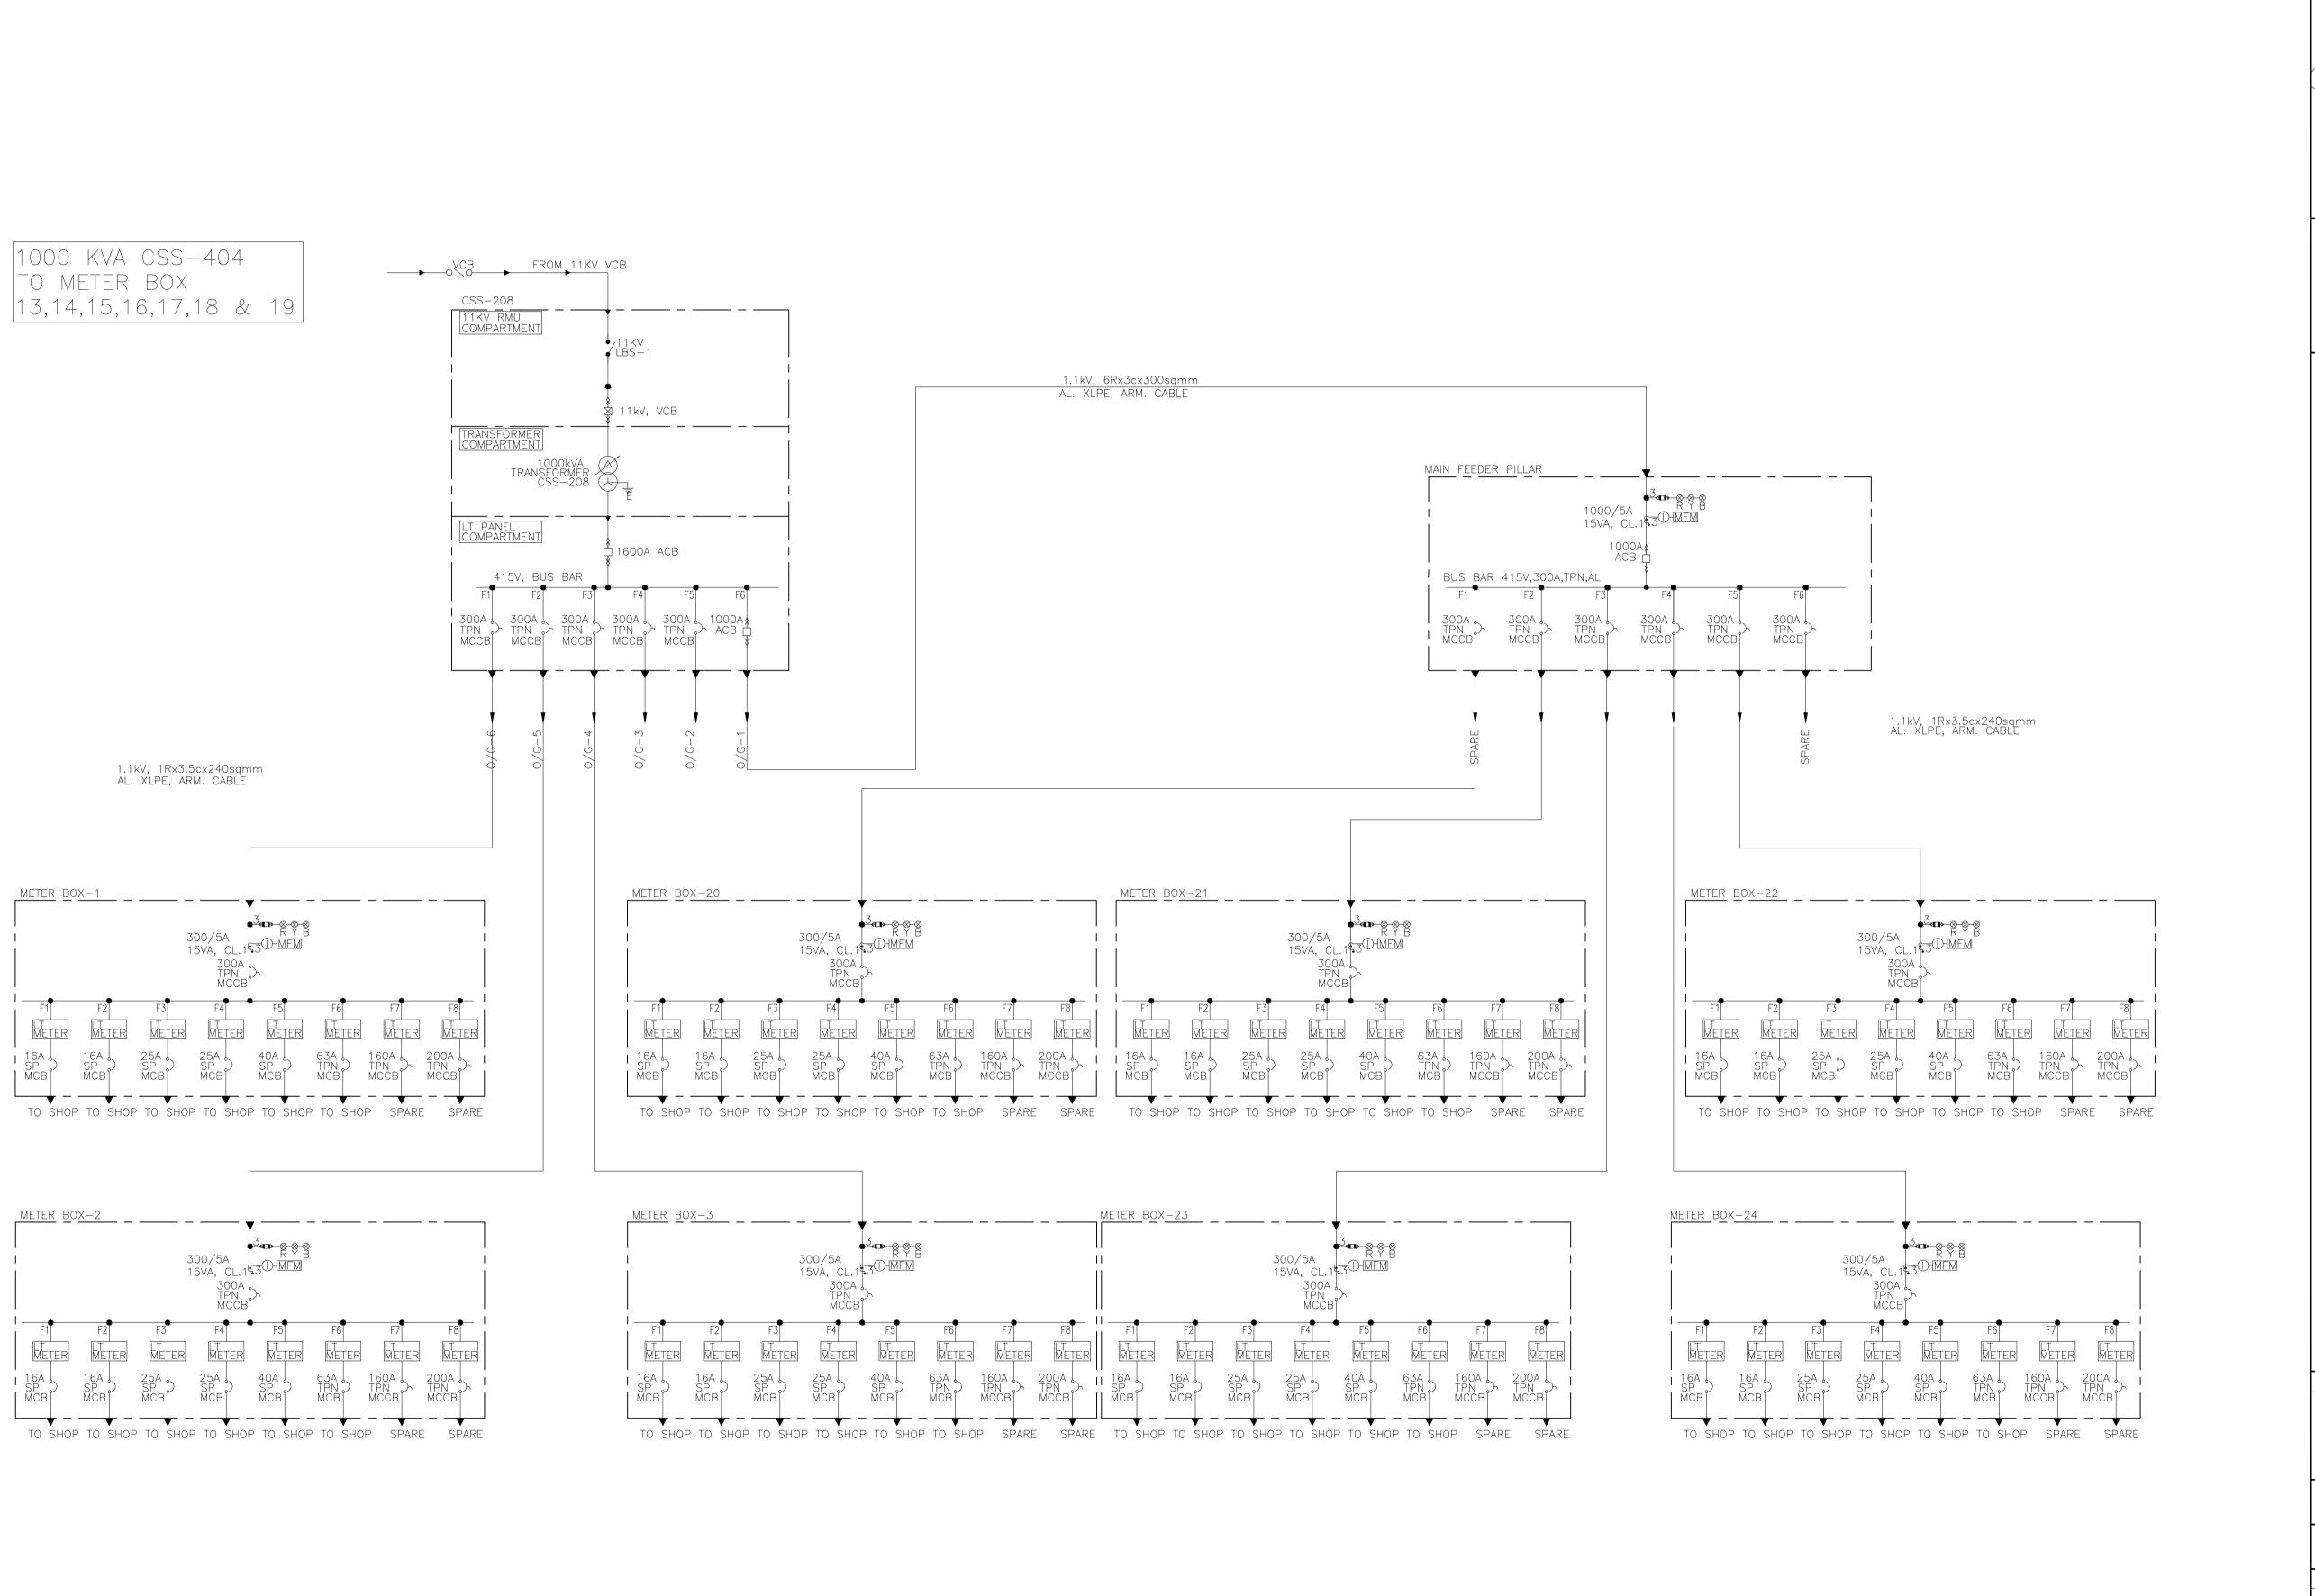

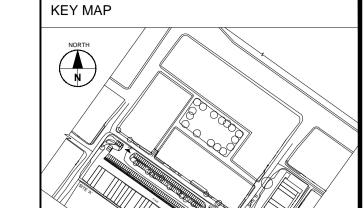

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- . THIS DRAWING MUST NOT BE COPIED IN WHOLE OR PART WITHOUT PRIOR WRITTEN CONSENT FROM AECOM.
- THIS DRAWING IS FOR INFORMATION ONLY.

<u>LEGEND</u>

- ⊗ INDICATION LAMP
- HT FUSE
- MFM MULTIFUNCTION METER
- CURRENT TRANSFORMER (CT)
 (FIGURE INDICATES NO. OF PTs)
- INSTRUMENTATION

DESCRIPTION DRWN CHKD DATE

LUDHIANA SMART CITY LIMITED

RETROFITTING AND FACADE IMPROVEMENT OF SARABHA NAGAR MARKET

PRELIMINARY DESIGN REPORT

FOR TENDER

RETROFITTING SCHEME: PROPOSED

SINGLE LINE DIAGRAM FOR CSS(404) TO METER BOX(13 TO 19)

A0 DELD-LSCL-100 -TP- RSN- 3023 **AECOM**

